ENGINEERING REPORT

HOLLAND MARSH DRAINAGE SYSTEM CANAL IMPROVEMENT PROJECT

TOWN OF BRADFORD WEST-GWILLIMBURY

COUNTY OF SIMCOE

TOWNSHIP OF KING

REGION OF YORK

"DRAWINGS"

VOLUME 3

January 16, 2009

File No. 03-023

K. SMART ASSOCIATES LIMITED
Kitchener Sudbury New Liskeard Rainy River

TABLE OF CONTENTS

Drawing 1 – Watershed Plan – shows the entire limit of lands that have water draining to the Holland Marsh Drainage System.

It shows there are 6 different municipalities with lands in the watershed.

This drawing indicates some of the major Highways, roads, Lots and Concessions.

As well, for the Town of Bradford West Gwillimbury the areas for 3 separate assessment roll numbers are shown.

Other Municipal drains, North Branch River and Kettleby Creek and their watersheds are shown.

Drawing 2 – is similar detail to drawing 1 but has information and location of all components of Holland Marsh Drainage System.

Drawing 3 – shows the North and South Canals and the Eighteen (18) Study Intervals along them. These Intervals were created to study the different sections of the Canal and determine the construction or improvements required. A brief description of the Construction Work in each Interval is listed along the sides of the drawing.

Drawings 4 to 14 – These are plan and profile drawings.

The plan portion along the top of the drawing shows the names of the property owners that abut the canal. Also shown, as identification, are property assessment roll numbers.

A legend along the right hand side of the drawings, indicate items on the plan, such as where the canal is to be relocated and survey cross section locations.

Along the bottom of these drawings is a profile which matches the same length of canal on the plan portion. The profile indicates the elevation of the road or dyke, the approximate depth of the existing canal and the proposed new depth or bottom and the calculated 100 year flood levels.

Soil borehole data is also shown as determined from field data and previous reports.

The profile is also used to show the approximate position of new drainage catchbasin positions alongside the road or canal dyke.

Drawings 15 to 51- these aerials show the work and owners along the North Canal and at a larger scale.

Drawings 52 to 92- these aerials show the work and owners along the South Canal and at a larger scale.

These drawings have an air photograph image in the background. Note, some distortion occurs with the images so that property lines do not always line up exactly.

Also note there is a description of the Extent of Work or construction that is to take place in that section of Canal. For example, the type of canal work (relocation, cleanout), clearing of bush required, hauling of excavated material, proposed irrigation lines, catchbasin and stockpile locations, etc.

Names of the property owners that abut the canal are shown, property assessment roll numbers and street addresses. Ownership status of the canal and dyke lands is also described.

Also shown are the approximate locations of fish mitigation items.

Drawings 93 to 102 - North Canal. These are cross sections to show the proposed work in the canal at various locations.

Drawings 103 to 116 - South Canal. These are cross sections to show the proposed work in the canal at various locations.


Cross section drawings indicate the depth and width of the improved/relocated canal in relationship to the existing road or dyke and canal. Depths and widths of cleanouts and levelling are also shown.


Drawings 117 to 119 – Detail drawings -Section of raised or widened dyke, Procedures for mitigation of flooding during construction, Capping plate on irrigation lines, Check Valve detail

Drawings 120 to 157 - Bridge drawings


These are preliminary drawings to show the existing conditions and the alternatives for any required work that will be necessary at various bridges across both the North and South canals. These enlargement and replacement drawings are conceptual/preliminary only and final design drawings would have to be produced prior to construction. Text in Volume 1 further describes the bridge work necessary.

NOTE: Full size drawings are available for review at the Board or Engineer's office.

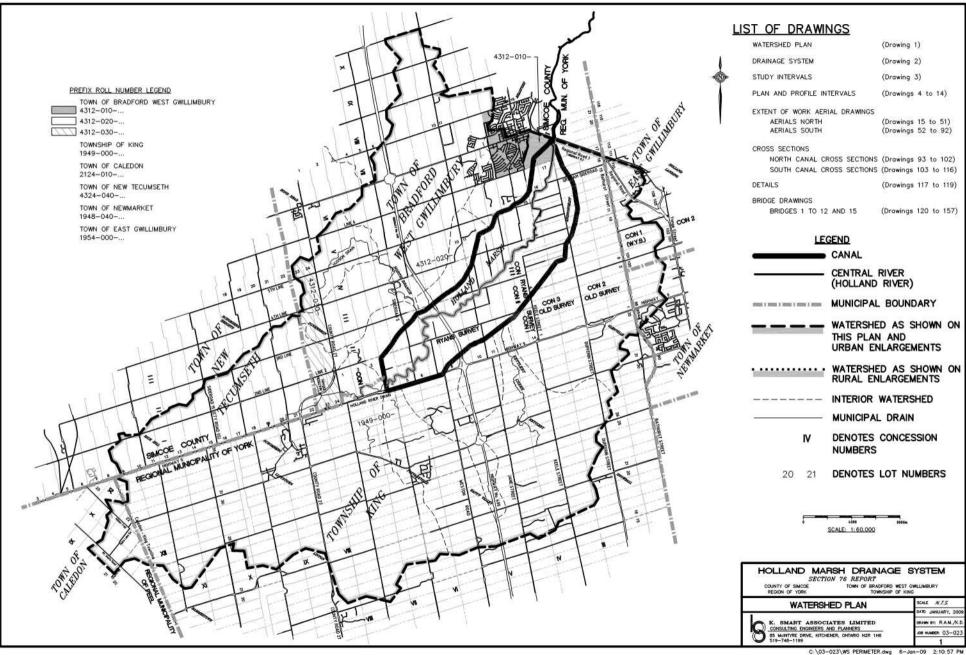

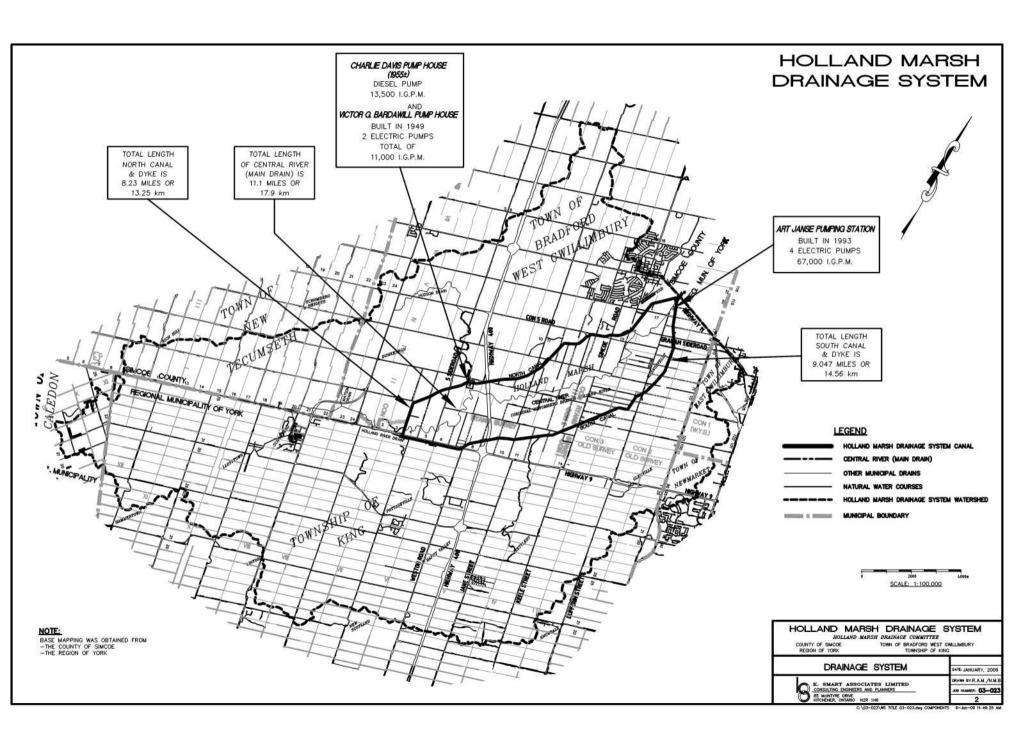

DRAWING 3 STUDY INTERVALS AND RECOMMENDED WORK

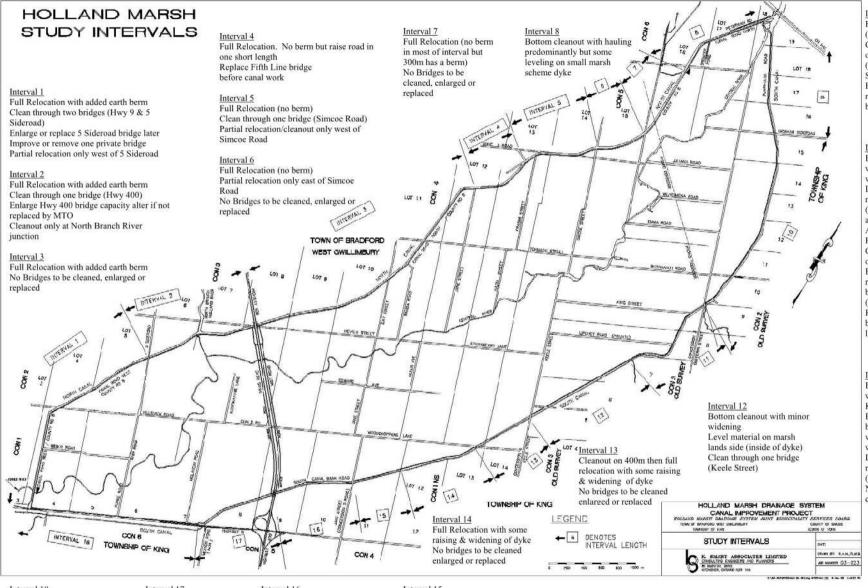

Interval 18
Bottom cleanout with some leveling on boulevard between Hwy 9and canal Hauling away of balance No bridges to be cleaned, enlarged or replaced

Interval 17
Full Relocation with berm
Clean through one bridge
(Highway 9)


Interval 16
Full Relocation with berm
Clean through Highway 400
overpass
Enlarge Highway 400 bridge
capacity if not replaced by MTO


Interval 15
Full Relocation with some raising & widening of dyke Replace Jane Street bridge prior to canal work

Interval 9
Full Relocation
(no berm)
Clean through
one bridge
(Graham
Sideroad)
Enlarge or
replace same
bridge later


Interval 10 Bottom cleanout with minor widening Level material on marsh lands side (inside) of dyke adjacent to lots in Ansnorveldt. Haul excavation Clean through one bridge Enlarge or replace same bridge later (Dufferin St) Replace private bridge with new laneway (done)


Interval 11
Bottom cleanout
with hauling by
King Road
Elsewhere,
bottom cleanout
with minor
widening
Level material on
marsh lands side
(inside) dyke
No bridges to be
cleaned

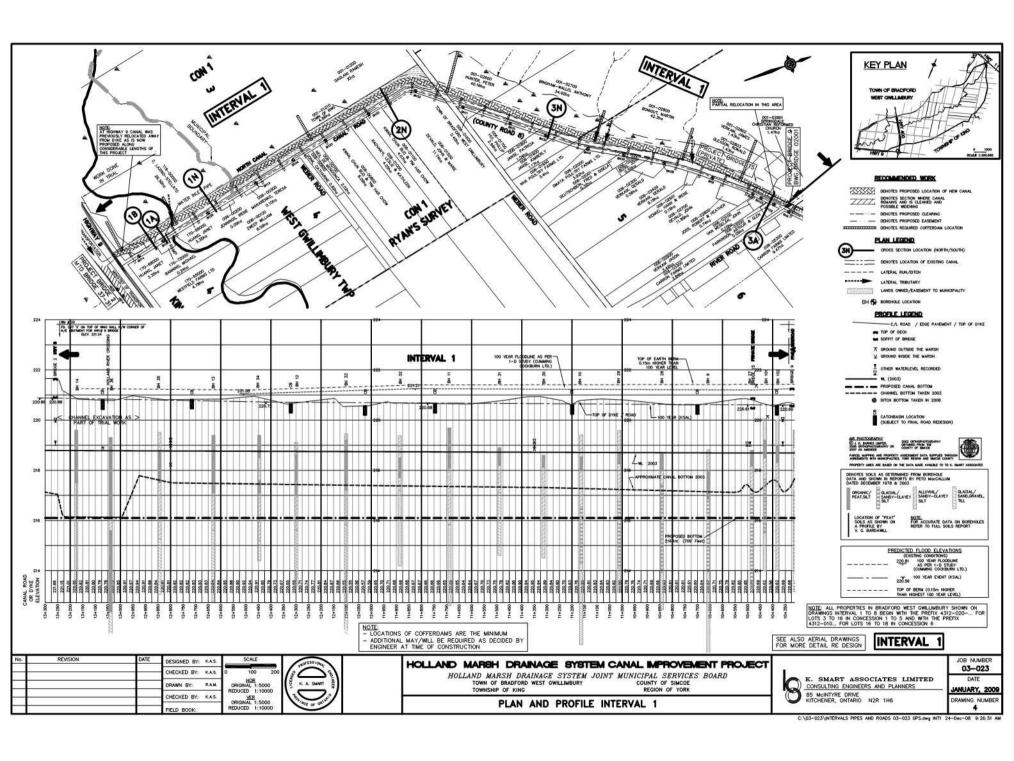


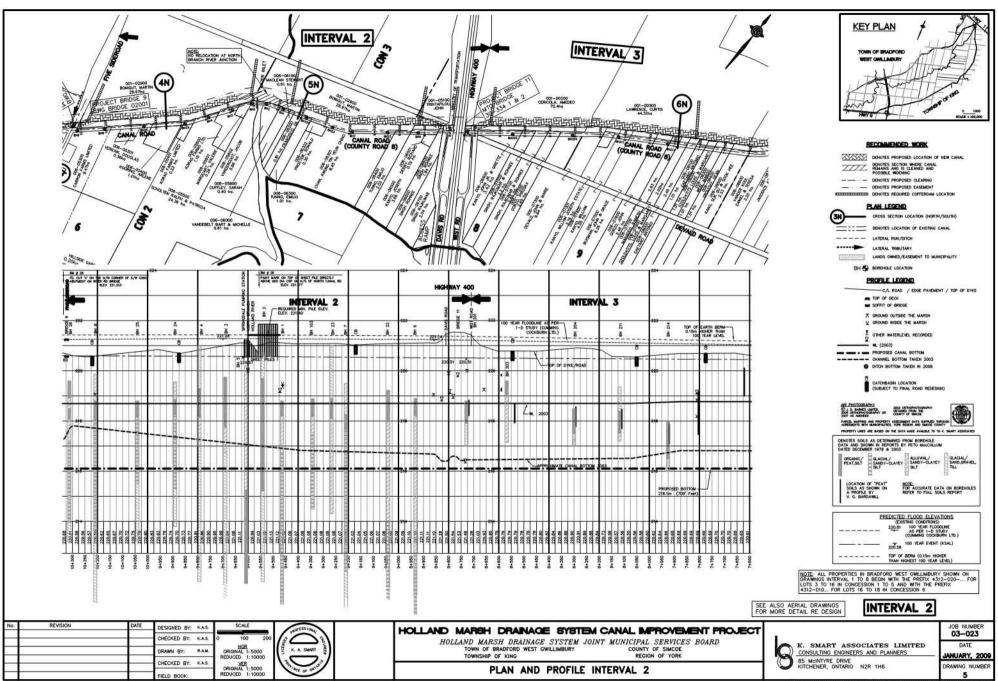


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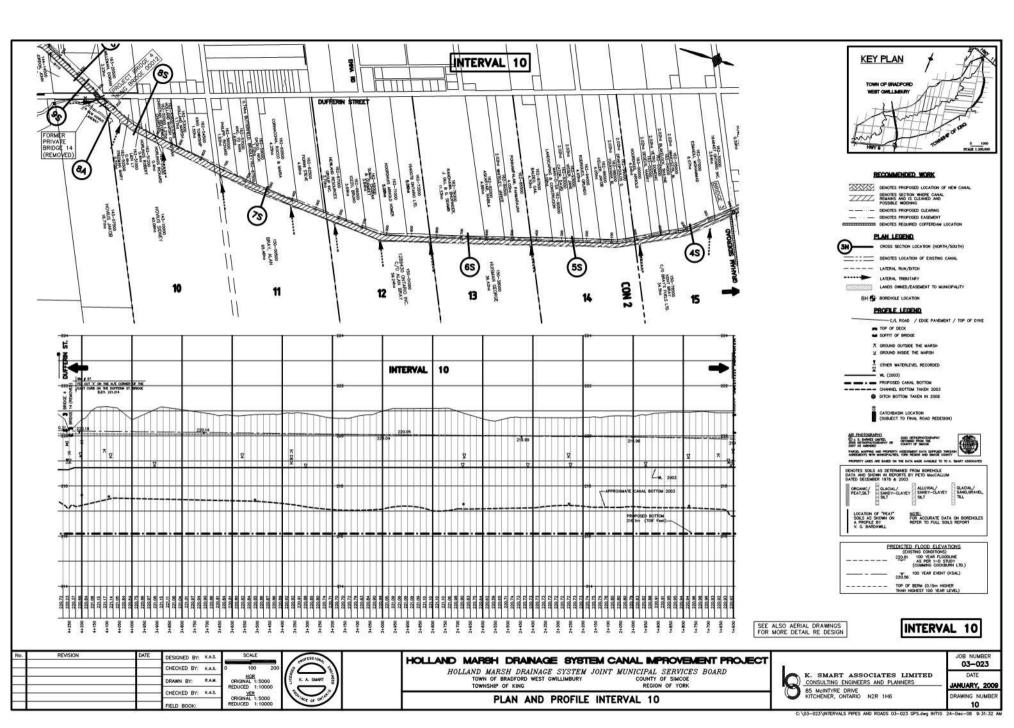


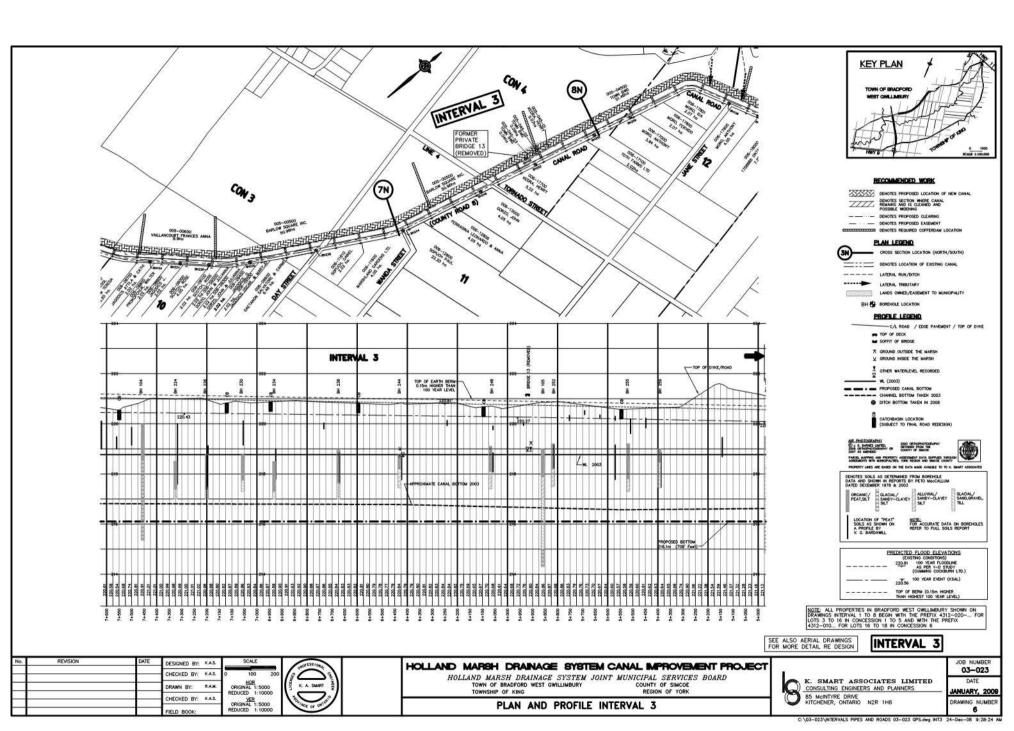
PLAN AND PROFILE INTERVAL 9

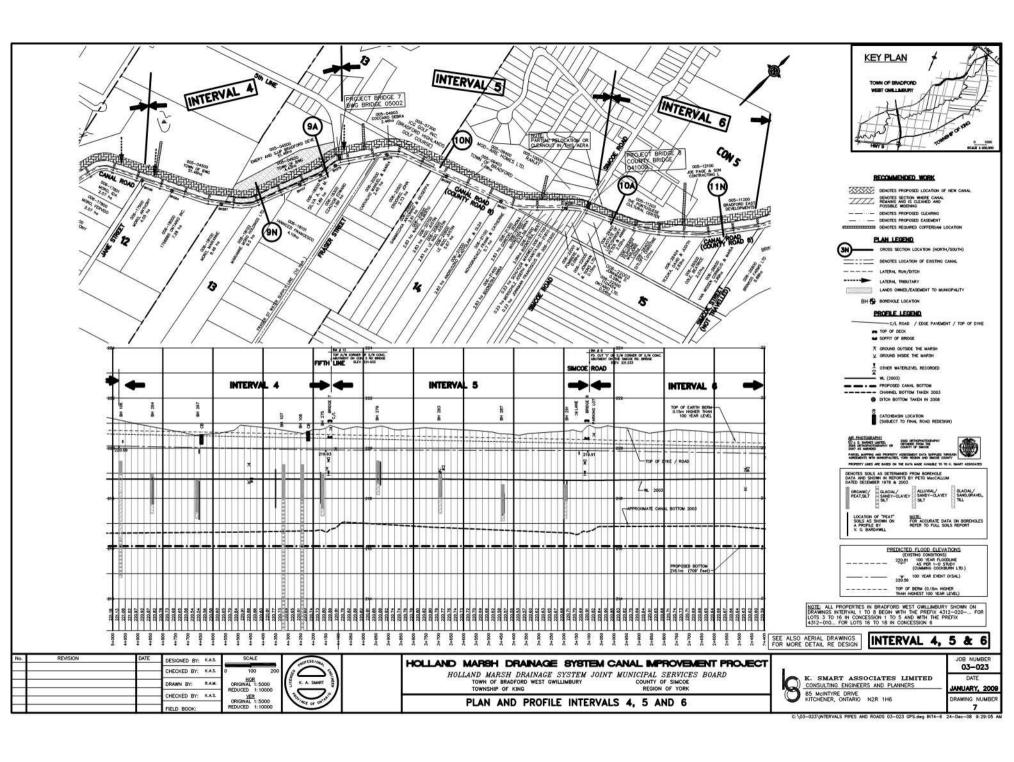
ORIGINAL 1:5000 REDUCED 1:10000

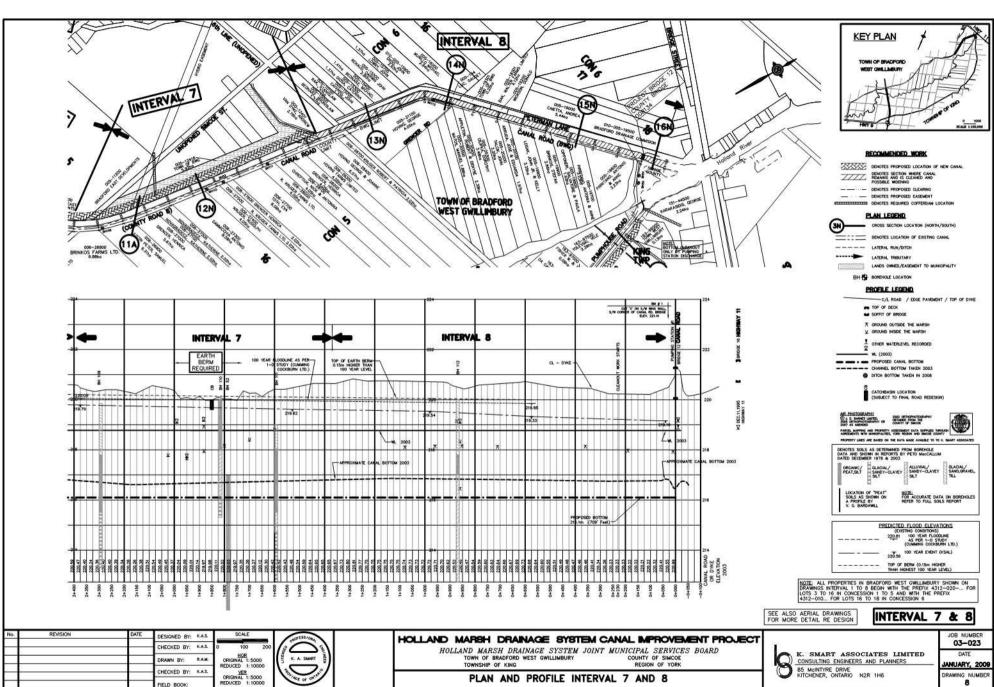
JANUARY, 2009 85 McINTYRE DRIVE KITCHENER, ONTARIO N2R 1H6 DRAWING NUMBER


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Extent of Work 13+200 to 13+130 - Type I canal work - place materials to east of cofferdam 70m (already done) Interval 1 (Part of Contract 1A and 1B) - Construct 80m long cofferdam (may be steel, earth, 80m (already done) KEY PLAN 13+300 to 13+260 - Type III-H-L canal work - clean bottom and level on adjacent rock or geobasket) lands. Maintain existing width. Some may have to be hauled 13+200 to 13+000 - May be request to do new Type A5 Irrigation line work in the future 13+130 to 12+900 - Type II canal work 230m (already done) 13+260 to 13+245 - Clean through Highway 9 bridge and level on adjacent lands 15m 13+030 - Irrigation (river inlet) line (250mm) - Type EC work - Approximately 500m3. (Type VI canal work) (300mm dia pipe with screen, retain existing vault and 12+980 - Lateral ditch treatment (already done) One (1) join new pipe to it) One (1) (clay base already done) 13+245 to 13+200 - Type III -L canal work. Materials to be stockpiled to east 45m 13+075+ - CB and outlet (Engineer to locate) One (1) And then placed on east side of new cofferdam once dry. Stockpile area to be enclosed with silt fence. Canal work from 12+900 to 13+200 already completed as Trial work on Interval 1. All new Type A irrigation lines are 200mm dia, unless noted. Gravel substrata and macrophyte work still needed MTO, HUANG AND TOWN OWN CANAL LAND, ROAD IS 66' ROW IN KING AND 66' ROAD ALLOWANCE IN BWG LOT 3 CON FULL RELOCATION MTO BRIDGE 37-CANAL ROAD 66' ROAD ALLOWANCE SIMCOE ROAD 8 = 8.5 66' ROW 283 & #269 (BG) NING, MICHAEL ZWEEP, WILLIAM LOT 4 CON PLAN LEGEND Interval 1 Quantities: INTERVAL 1 RELOCATED DITCH ACCESS ROUTE Clearing (Part of Contract 1A) FISH HABITAT LEGEND APPROXIMATE LOCATION AND SIZE OF EXISTING PIPE OR SLEEVE ACROSS DYKE ABOVE NOTE: THE WORKING AREA IS TO BE THE OUTSIDE LIMITS OF ANY CLEARING AND TOPSOL STRIPPING AREA SHOWN, THE DYKES ("METHER THEY ARE DRIT, GRAVEL, PAVED, AND USED BY PUBLIC OR NOT) AND THE EXISTING CANAL. THE WORK AREA IS ALSO TO INCLUDE ANY DESIGNATED AND/OR APPROVED ACCESS AREAS. LIMIT OF CLEARING * FOR a) For relocation - 24m wide, Sta. 10+510 to 12+900 = 5.8 ha (FINAL LOCATION TO BE SET TIME OF CONSTRUCTION) Earth work CANAL (NOT ALWAYS SHOWN) GRADE UNLESS NOTED AS BELOW GRADE (BG)
A2 ETC. PROPOSED NEW IRRIGATION WORK b) Along edge of dyke - Sta. 10+350 to 12+900 as required OO GUIDE RAIL - To haul during excavation 3,500m3 - approximately 33% of length has trees (SEE EXTENT OF WORK NOTES RE NEW IRRIGATION WORK)

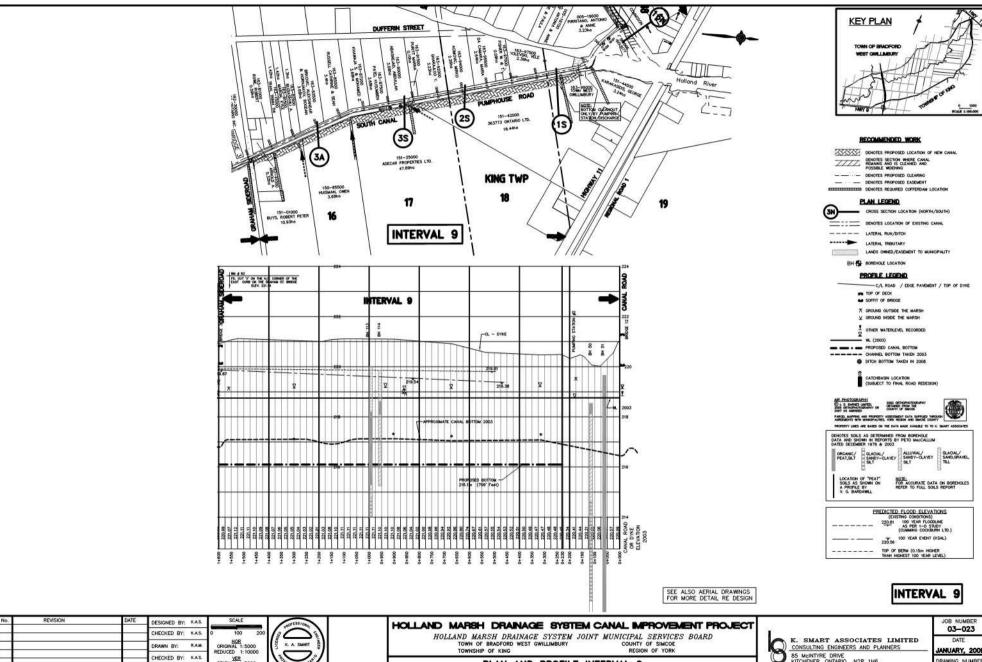EXISTING WELL (SEE EXTENT OF WORK NOTES) - To excavate and backfill (relocations) 89,500m3 BELL LINE DEEP POOLS Berm Work (part of Contract 1A) - Total excavation 93,000m3 UNDER GROUNG GAS LINE - 23,500m3 of additional material to be hauled in and graded PROPOSED CATCHBASIN LOCATION AND OUTLET PIPE NEW CANAL BANK - Leveling 40,000m2 Berm Work (part of Contract 1B) MACROPHYTE - Material to be brought in to finish berm 23,500m3 TRANSPLANTS - 2,900m long (Sta.10+550 to 13+250) OVERHEAD HYDRO AND POLE ---- PROPOSED LEVELLING AREA BOUNDARY - Ouantities do not include deep pool excavation LITTORAL SHELF PROPOSED TEMPORARY STRIPPED TOPSOIL STOCKPILE OR CLEARING BOUNDARY FOR LEVELLING - 40,000m3 shaping and final grading HYDRO POLE (TO MOVE IF X) GRAVEL 200000 - 2,900m of swale work --- PROPOSED BUFFER AP & ANCHOR POLE (TO MOVE IF X) SUBSTRATES - 2,900m of seeding and planting on berm FULL FULL RELOCATION OF EXISTING CANAL (13) CROSS-SECTION LOCATION PARTIAL PARTIAL RELOCATION OF EXISTING CANAL - Eight catchbasins and outlets ROOT MASSES OR LOG BUNDLES ROW RIGHT-OF-WAY IN FIELD AREAS IT IS LIMIT OF TOPSOIL STRIPPING PIN PROPERTY IDENTIFICATION NUMBER REVISION JOB NUMBER HOLLAND MARSH DRAINAGE SYSTEM CANAL IMPROVEMENT PROJECT SCALE 03-023 HOLLAND MARSH DRAINAGE SYSTEM JOINT MUNICIPAL SERVICES BOARD K. SMART ASSOCIATES LIMITED DATE 10 TOWN OF BRADFORD WEST GWILLIMBURY COUNTY OF SIMCOE CONSULTING ENGINEERS AND PLANNERS ANUARY, 2009 ORIGINAL SCALE 85 McINTYRE DRIVE KITCHENER, ONTARIO 1:1000 DRAWING NUMBE AERIAL VIEW OF PROPERTIES AND EXTENT OF WORK NOTES 15

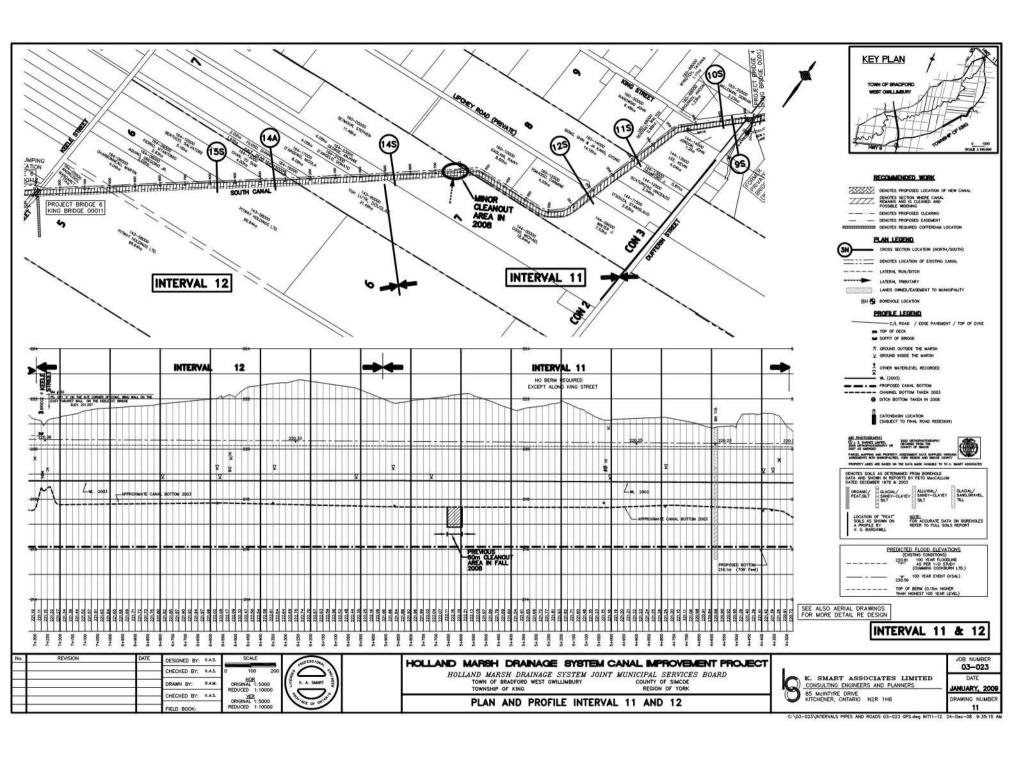Extent of Work

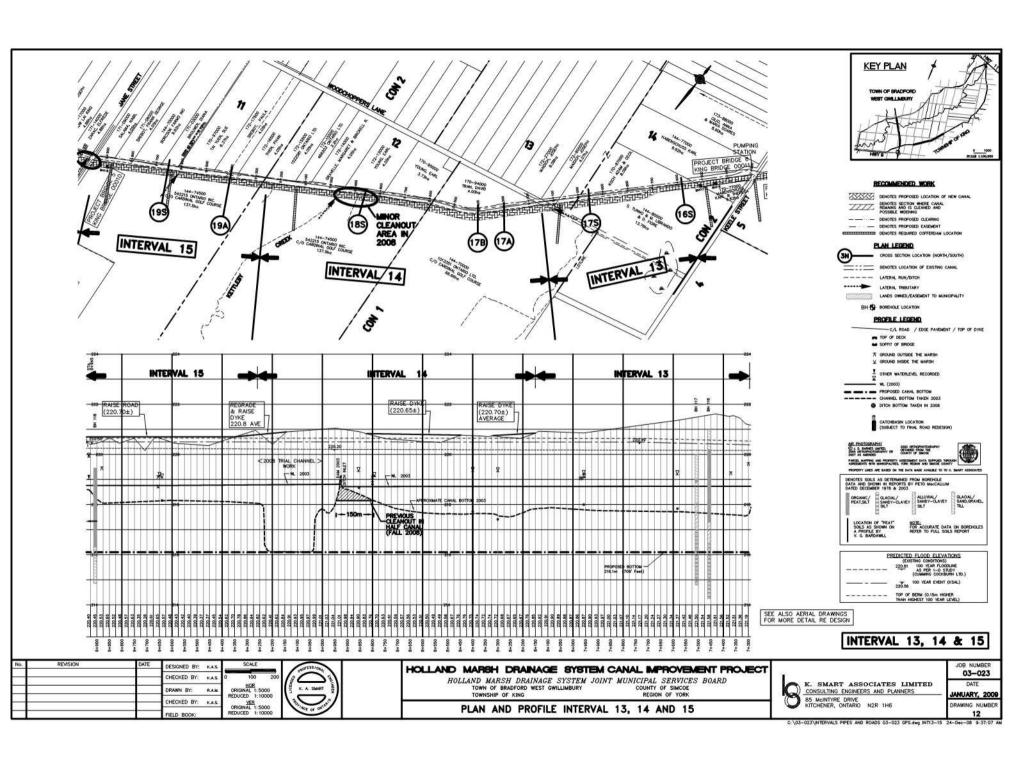Interval 1 Cont.

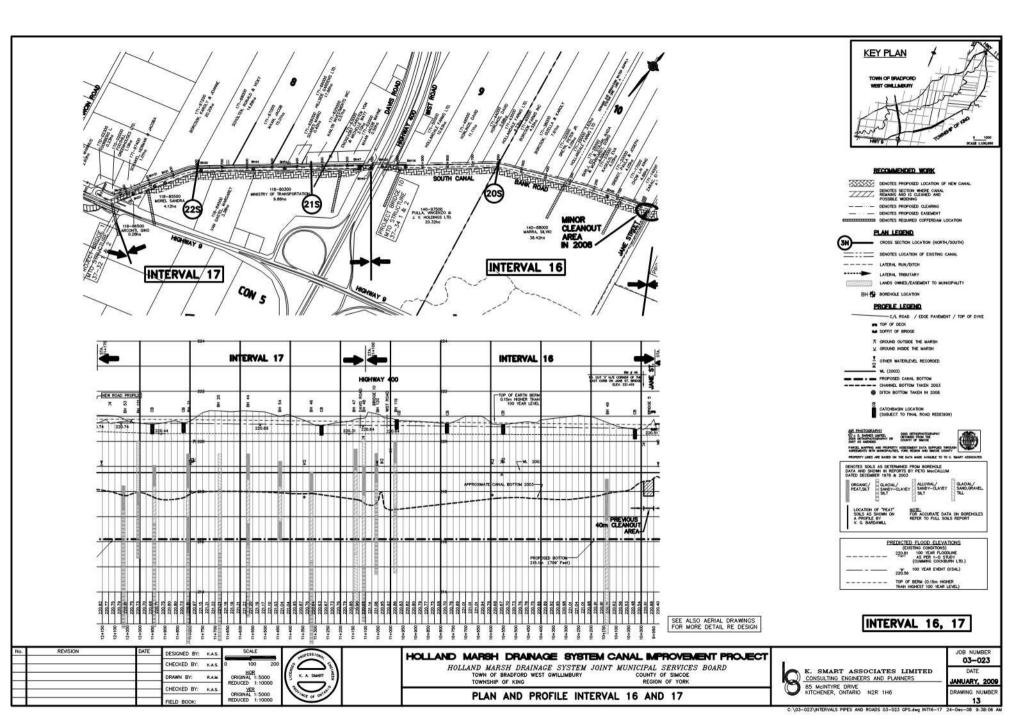12+900 to 12+520 - Type II canal work 380m 12+700± - CB & outlet - Engineer to locate One(1)

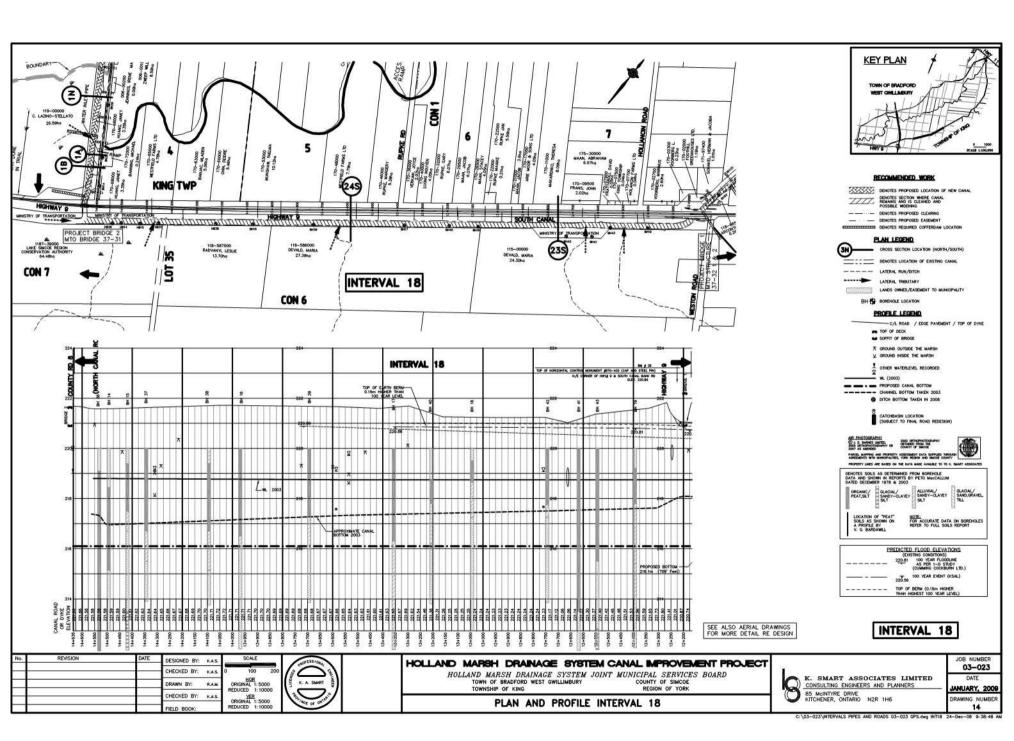
10

ORIGINAL SCALE

1:1000

KEY PLAN

TOWN OWNS CANAL LAND, ROAD IS 66' ALLOWANCE

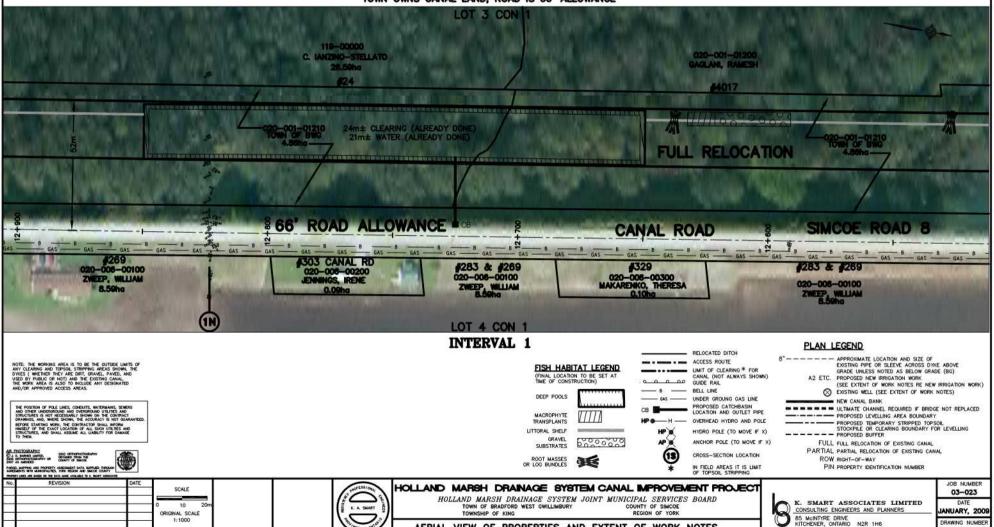

TOWN OF BRADFORD WEST GWILLIMBURY

AERIAL VIEW OF PROPERTIES AND EXTENT OF WORK NOTES

TOWNSHIP OF KING

COUNTY OF SIMCOE

85 McINTYRE DRIVE KITCHENER, ONTARIO

ANUARY, 2009

DRAWING NUMBE

Extent of Work Interval I Cont. 12+520 to 12+150 - Type II canal work 370m - New irrigation line - Type A5 work 12+490± One (1) 12+419 - Irrigation line 50mm - New Type B work One (1) 12+402 - Irrigation line 250mm - New Type A2 work One (1) 12+366 to 12+330 - Provide new irrigation line. Type A5 work (200mm) One(1) 12+346 - Well location - do well extension (Type GE work) One (1) - Do well raising - Type G-R work One (1) - Irrigation line 150mm - new Type A2 work 12+260 One (1) 12+260 - Abandoned well work required One (1) - CB & outlet - Engineer to locate 12+320± One(1) TOWN OWNS CANAL, 66' ROAD ALLOWANCE LOT 3 CON 1 001-01200 GAGLANI, RAMESH \$4017 001-01210 24m± CLEARING 21m± WATER **FULL RELOCATION** 66' ROAD ALLOWANCE CANAL ROAD (SIMCOE ROAD 8

INTERVAL 1

LOT 4 CON 1

FISH HABITAT LEGEND (FINAL LOCATION TO BE SET AT TIME OF CONSTRUCTION) MACROPHYTE

020-006-00800

KWAN, CHUN BUD & YM HAR CH

TRANSPLANTS LITTORAL SHELF GRAVEL SUBSTRATES

600000 (13)

RELOCATED DITCH ACCESS ROUTE LIMIT OF CLEARING * FOR CANAL (NOT ALWAYS SHOWN) O.O GUIDE RAIL BELL LINE UNDER GROUNG GAS LINE PROPOSED CATCHBASIN LOCATION AND OUTLET PIPE OVERHEAD HYDRO AND POLE

> HYDRO POLE (TO MOVE IF X) ANCHOR POLE (TO MOVE IF X) CROSS-SECTION LOCATION IN FIELD AREAS IT IS LIMIT OF TOPSOIL STRIPPING

PLAN LEGEND

- APPROXIMATE LOCATION AND SIZE OF EXISTING PIPE OR SLEEVE ACROSS DYKE ABOVE GRADE UNLESS NOTED AS BELOW GRADE (BG) A2 ETC. PROPOSED NEW IRRIGATION WORK

KEY PLAN

(SEE EXTENT OF WORK NOTES RE NEW IRRIGATION WORK) EXISTING WELL (SEE EXTENT OF WORK NOTES) NEW CANAL BANK

020-008-01000 NYL LESLE & KATHLEEN

- - - - ULTIMATE CHANNEL REQUIRED IF BRIDGE NOT REPLACED ---- PROPOSED LEVELLING AREA BOUNDARY PROPOSED TEMPORARY STRIPPED TOPSOIL STOCKPILE OR CLEARING BOUNDARY FOR LEVELLING

--- PROPOSED BUFFER FULL FULL RELOCATION OF EXISTING CANAL PARTIAL PARTIAL RELOCATION OF EXISTING CANAL ROW RIGHT-OF-WAY

PIN PROPERTY IDENTIFICATION NUMBER

REVISION SCALE 10 ORIGINAL SCALE 1:1000

NOTE: THE WORKING AREA IS TO BE THE OUTSIDE LIMITS OF ANY CLEARING AND TOPSOL STRIPPING AREAS SHOWN, THE DYSES (WHITEDER THEY ARE DRIT, GRAVE), AND USED BY PUBLIC OR NOT), AND THE EXISTING CANAL. THE WORK AREA IS ALSO TO INCLUDE ANY DESIGNATED AND/OR APPROVED ACCESS MEES.

PARCE, MAPPING AND PROPERTY ASSESSMENT DATA SUPPLIED THROUGH AGRETACHTS WITH MANOPAUTES, YORK REGION AND SMICH COUNTY

286 & 4269

020-006-00100

ZWEEP. WILLIAM

8.59ha

ROAD

8 83



HOLLAND MARSH DRAINAGE SYSTEM CANAL IMPROVEMENT PROJECT

HOLLAND MARSH DRAINAGE SYSTEM JOINT MUNICIPAL SERVICES BOARD TOWN OF BRADFORD WEST GWILLIMBURY COUNTY OF SIMCOE TOWNSHIP OF KING

AERIAL VIEW OF PROPERTIES AND EXTENT OF WORK NOTES



K. SMART ASSOCIATES LIMITED CONSULTING ENGINEERS AND PLANNERS 85 McINTYRE DRIVE KITCHENER, ONTARIO

JOB NUMBER 03-023 ANUARY, 2009 DRAWING NUMBE 17

Extent of Work 12+055 to 11+900 - Existing water line in canal bottom to remain (no work) Interval I Cont. 12+025 - CB and outlet - Engineer to locate 12+150 to 11+900 - Type II canal work 250m 11+940 - Move anchore pole and extend line 12+150± - Abandoned well work required One (1) 11+900 to 11+945 - Remove existing guide rail 12+120± - Irrigation line 250mm to 300mm sleeve Type A2 work (250mm) One(1) 12+113 - There is outlet from new building side well to extend Type G-E work One(1) 12+099 - Irrigation line 200mm - Type A2 work One (1) - Raise existing concrete well casing to level of new 12+055 berm (Type G-R work) One (1) - Ensure existing line that enters and exits casing is maintained TOWN OWNS CANAL, 66' ROAD ALLOWANCE LOT 3 CON 1 020-001-01200 GAGLANI, RAMESH #4017 **FULL RELOCATION** ROAD ALLOWANCE ROAD (2N) 020-008-01000 RADVANYI, LESLE & KATHLEEN

REVISION

SCALE

10

ORIGINAL SCALE

1:1000

One (1) One (1) 45m





HOLLAND MARSH DRAINAGE SYSTEM CANAL IMPROVEMENT PROJECT

HOLLAND MARSH DRAINAGE SYSTEM JOINT MUNICIPAL SERVICES BOARD

AERIAL VIEW OF PROPERTIES AND EXTENT OF WORK NOTES

COUNTY OF SIMCOE

TOWN OF BRADFORD WEST GWILLIMBURY

TOWNSHIP OF KING

K. SMART ASSOCIATES LIMITED

CONSULTING ENGINEERS AND PLANNERS


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03-023


ANUARY, 2009

18

DRAWING NUMBE

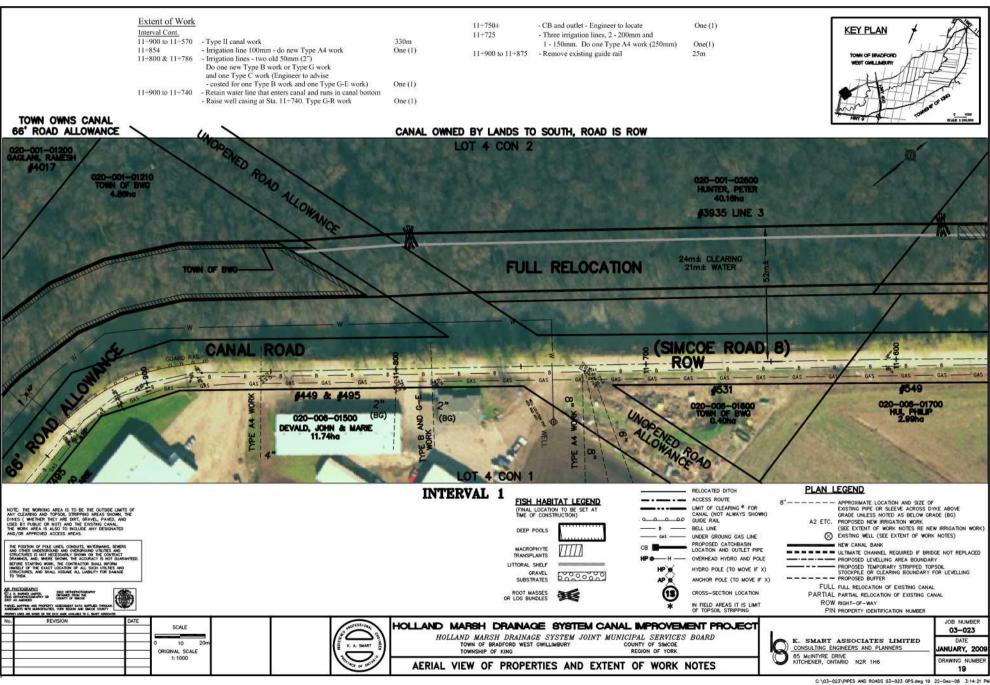

Extent of Work Interval I Cont. 11+570 to 11+180 - Type II canal work 390m 11+478 - Irrigation line 200mm - Type A2 work One (1) - Well location - outlet extension Type G-E work 11+424 One (1) and raise casing if necessary (Type G-R work) One (1) 11+364 - Irrigation line 50mm. No work required. Owner to do any work required One (1) 11+310 - Irrigation line 125mm - Type A2 work One (1) 11+312 - Well location - raise and extend casing - Type G-R work One (1) 11+296 - Irrigation line 50mm - Type B work One (1) 11+223 - Irrigation line 100mm - Type A2 work One (1) 11+200 - CB and outlet - Engineer to locate One (1) CANAL OWNED BY LANDS TO SOUTH, ROAD IS ROW LOT 4 CON 2 020-001-02700 IAM-WALLIS, ANTHONY 43885 LINE 3 24m± CLEARING 21m± WATER FULL RELOCATION

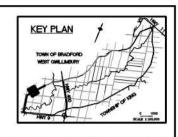



RELOCATED DITCH --- ACCESS ROUTE FISH HABITAT LEGEND LIMIT OF CLEARING * FOR (FINAL LOCATION TO BE SET AT TIME OF CONSTRUCTION) CANAL (NOT ALWAYS SHOWN) GUIDE RAIL BELL LINE UNDER GROUNG GAS LINE PROPOSED CATCHBASIN LOCATION AND OUTLET PIPE MACROPHYTE OVERHEAD HYDRO AND POLE TRANSPLANTS LITTORAL SHELF HYDRO POLE (TO MOVE IF X) GRAVEL 500000 ANCHOR POLE (TO MOVE IF X) SUBSTRATES CROSS-SECTION LOCATION

IN FIELD AREAS IT IS LIMIT OF TOPSOIL STRIPPING

PLAN LEGEND APPROXIMATE LOCATION AND SIZE OF EXISTING PIPE OR SLEEVE ACROSS DYKE ABOVE GRADE UNLESS NOTED AS BELOW GRADE (BG)
A2 ETC. PROPOSED NEW IRRIGATION WORK (SEE EXTENT OF WORK NOTES RE NEW IRRIGATION WORK EXISTING WELL (SEE EXTENT OF WORK NOTES) - NEW CANAL BANK

---- PROPOSED LEVELLING AREA BOUNDARY PROPOSED TEMPORARY STRIPPED TOPSOIL
 STOCKPILE OR CLEARING BOUNDARY FOR LEVELLING
 PROPOSED BUFFER FULL FULL RELOCATION OF EXISTING CANAL PARTIAL PARTIAL RELOCATION OF EXISTING CANAL

ROW RIGHT-OF-WAY PIN PROPERTY IDENTIFICATION NUMBER

HOLLAND MARSH DRAINAGE SYSTEM CANAL IMPROVEMENT PROJECT

K. SMART ASSOCIATES LIMITED CONSULTING ENGINEERS AND PLANNERS 85 McINTYRE DRIVE KITCHENER, ONTARIO

JOB NUMBER 03-023 ANUARY, 2009 DRAWING NUMBE 20

PROPERLY LINES AND BASED ON THE EXTA MADE ANALYSES TO A SHAPE ADMINISTRA						
No.	REVISION	DATE	****			
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-		_	0 10 20m			
18			ORIGINAL SCALE 1: 1000			
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NOTE: THE WORKING AREA IS TO BE THE OUTSIDE LIMITS OF ANY CLEARING AND TOPSOL STREPPING AREAS SKOWN, THE OTHICS (WIETHER THEY ARE DRIT, GRAVEL, PAND), AND USED BY PUBLIC OR NOT) AND THE EXISTING CANAL. THE WORK AREA IS ALSO TO INCLUDE ANY DESIGNATED.




HOLLAND MARSH DRAINAGE SYSTEM JOINT MUNICIPAL SERVICES BOARD

TOWN OF BRADFORD WEST GWILLIMBURY TOWNSHIP OF KING COUNTY OF SIMCOE

AERIAL VIEW OF PROPERTIES AND EXTENT OF WORK NOTES



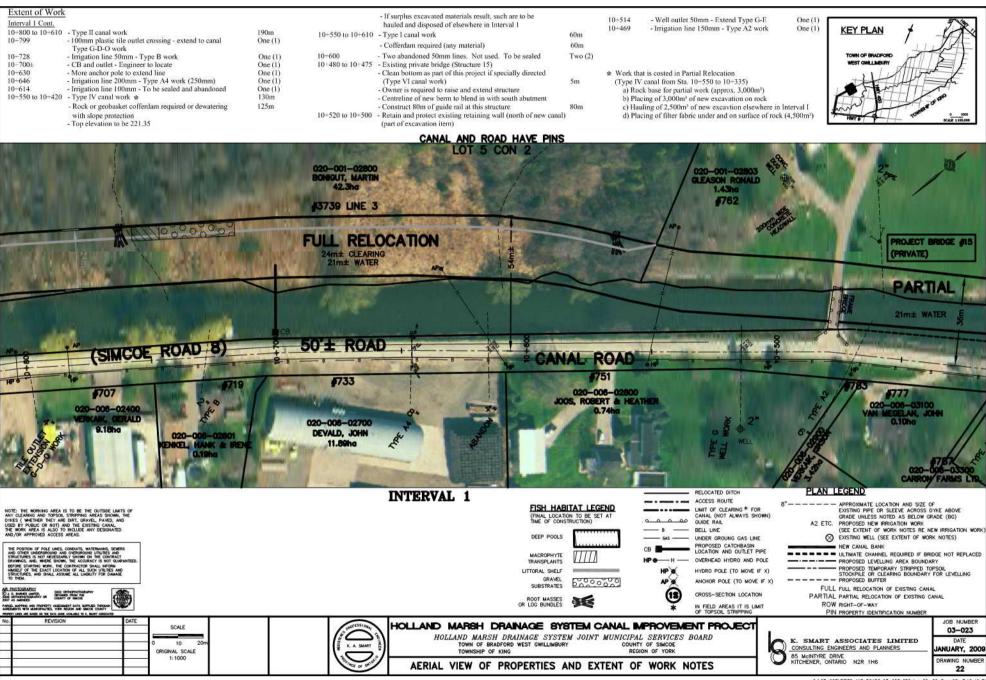

Extent of Work Interval 2 (Part of Contract 1A and 1B) 10+225± - CB and outlet - Engineer to locate One (1) Interval 1 Cont. 10+335 to 10+320± - Clean through existing structures (see structure 15m KEY PLAN 10+210 to 10+050 - Type II canal work 160m 10+420 to 10+335 - Type IV canal work (partial relocation) drawing) (Type VI canal work) 10+197 - Irrigation line 300mm communal Type EC work One (1) Rock or geobasket cofferdam required or dewatering - Materials to be disposed of with other materials 10+196 - Irrigation line 300mm - Do new Type A4 work with slope protection required - Ultimate work by Town is to enlarge or replace structure (250mm) One (1) - Top elev. to be 221.35 10+320 to 10+210 - Type I canal work 110m - If surplus excavated materials result, such are to - Cofferdam required (any material but to be flood proof) 110m be hauled and disposed of elsewhere in Interval I 10+297 & 10+268 - Two irrigation lines 50mm - Type B or C work (Type C 10+417 - 300mm plastic pipe fire line. Shorten line to fit new work is costed) for one. Type B work for the other One (1) bank. Salvage and reuse inlet and marker One (1) 10+230 - Irrigation line 150mm abandon One (1) One (1) 10+405 - Irrigation line 200mm - Type A2 work 10+380 - CB and outlet - Engineer to locate CANAL OWNED BY LAND TO NORTH, ROAD HAS PIN CANAL AND ROAD HAVE PIN LOT 6 CON 2 020-001-02801 SPRINGDALE CHRISTIAN REFORMED CHURCH 1.47hg 1466 SIDEROAD 5 #1483 SIDEROAD 5 ROJECT BRIDGE #9 TWP BRIDGE #2001 24m± CLEARING FULL RELOCATION 21m± WATER CANAL ROAD ROAD PO PO #1423 020-006-05300 CARRON FARMS LIM AIVER 9.47hg 0.09ha INTERVAL 1 =>= INTERVAL 2 PLAN LEGEND RELOCATED DITCH FISH HABITAT LEGEND ACCESS ROUTE (FINAL LOCATION TO BE SET AT TIME OF CONSTRUCTION) APPROXIMATE LOCATION AND SIZE OF EXISTING PIPE OR SLEEVE ACROSS DYKE ABOVE Cofferdam and Riprap Work at Bridge 9 (Sideroad 5 Structure): LIMIT OF CLEARING * FOR - New top of berm (elev. 221.35± on south side) to blend in with existing wingwalls (SE & SW) NOTE: THE WINNING AREA IS TO BE THE CUTSION UNITS OF ANY CLEARING AID TOPOOL STREPHING AREA SHOWN, THE DYCES (WIETHER THEY ARE DIRT, GRAVEL, PANED, ANY LUSED BY PUBLIC OR NOT) AND THE DISTING CANAL. THE WORK AREA IS ALSO TO INCLIDE ANY DESIGNATED AND/OR APPROVED ACCESS AREAS. CANAL (NOT ALWAYS SHOWN) GRADE LINLESS NOTED AS BELOW GRADE (BG) - Face of new berm is to taper out along the wingwalls. Interlocking sheet steel piles would also be acceptable. GUIDE RAIL DEEP POOLS A2 ETC. PROPOSED NEW IRRIGATION WORK (SEE EXTENT OF WORK NOTES RE NEW IRRIGATION WORK) Final design to recognize structure work to be done by Town - BELL UNE EXISTING WELL (SEE EXTENT OF WORK NOTES) UNDER GROUNG GAS LINE - Expected new edges of water are shown MACROPHYTE PROPOSED CATCHBASIN LOCATION AND OUTLET PIPE NEW CANAL BANK - Cofferdam extending from 10+210 to 10+320 in southeast quadrant to be geomembrane protected, TRANSPLANTS partial work earth slope or rock embankment to give 21m water width at 218.75. LITTORAL SHELF OVERHEAD HYDRO AND POLE ---- PROPOSED LEVELLING AREA BOUNDARY Top elev. to be 221.40. CRAVE PROPOSED TEMPORARY STRIPPED TOPSOIL STOCKPILE OR CLEARING BOUNDARY FOR LEVELLING 6000000 HYDRO POLE (TO MOVE IF X) SUBSTRATES - Interlocking steel sheet piling (12m± long sections) would also be accepted. ANCHOR POLE (TO MOVE IF X) ---- PROPOSED BUFFER - Heavy, angular rock riprap to be placed in NE and NW quadrant, to convey road ditch waters and ROOT MASSES OR LOG BUNDLES FULL FULL RELOCATION OF EXISTING CANAL CROSS-SECTION LOCATION PARTIAL PARTIAL RELOCATION OF EXISTING CANAL Approximate amount required is 100m³ on filter fabric, 1m thick and recessed in. $100 m^3$ ROW RIGHT-OF-WAY IN FIELD AREAS IT IS LIMIT OF TOPSOIL STRIPPING PIN PROPERTY IDENTIFICATION NUMBER REVISION JOB NUMBER HOLLAND MARSH DRAINAGE SYSTEM CANAL IMPROVEMENT PROJECT SCALE 03-023 HOLLAND MARSH DRAINAGE SYSTEM JOINT MUNICIPAL SERVICES BOARD K. SMART ASSOCIATES LIMITED 10 TOWN OF BRADFORD WEST GWILLIMBURY COUNTY OF SIMCOE CONSULTING ENGINEERS AND PLANNERS ANUARY, 2009 ORIGINAL SCALE TOWNSHIP OF KING

AERIAL VIEW OF PROPERTIES AND EXTENT OF WORK NOTES

1:1000

DRAWING NUMBE

Extent of Work

Interval 2 Cont.

9+703

10+050 to 9+700 - Type II canal work


9+965 - Irrigation line 125mm - may not be used. Type A2 work 9+851 - Irrigation line 250mm - Type E work


9+875± - CB and outlet - Engineer to locate 9+848

- Irrigation line 350mm - Type A2 work - Irrigation line 50mm - Type A2 work

350m One (1) One (1) One (1) One (1)

One (1)

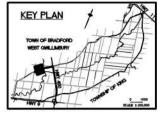

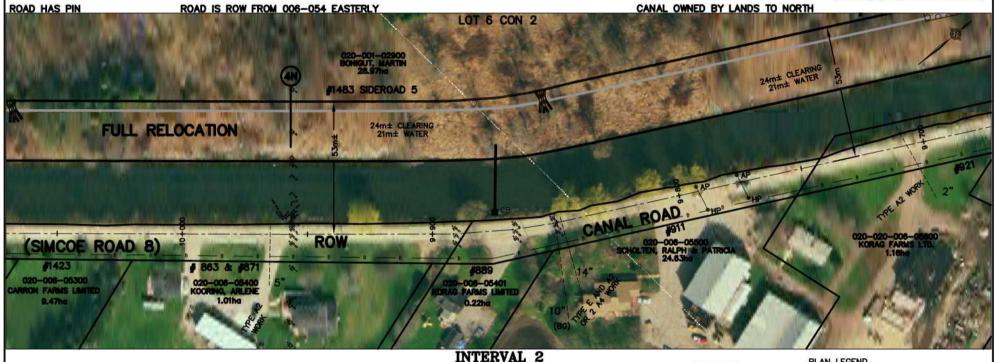

NOTE: THE WORKING AREA IS TO BE THE OUTSIDE LIMITS OF ANY CLEARING AND TOPSOIL STRIPPING AREA SHOWN, THE DYRKS (WHETHER THEY ARE OUT, GRAVEL, PAVED, AND USED BY PUBLIC OR NOT) AND THE ENISTING CANAL. THE WORK AREA IS ALSO TO INCLIDE, ANY DESIGNATED AND/OR APPROVED ACCESS AREAS.

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SIGN OFFROMVOTOGRAPHY OF COLUMN OF SHOOM

2007 AS AMERICAN PARCEL MAPPHO AND PROPERTY ASSESSMENT DATA SUPPLIED THROUGH AGRETACHTS WITH MANOGRAPHES, YORK REGION AND SMICE COUNTY REVISION



1:1000

FISH HABITAT LEGEND (FINAL LOCATION TO BE SET AT

DEED POOLS MACROPHYTE TRANSPLANTS LITTORAL SHELF GRAVEL 000000 SUBSTRATES

ROOT MASSES OR LOG BUNDLES

RELOCATED DITCH ACCESS ROUTE LIMIT OF CLEARING * FOR CANAL (NOT ALWAYS SHOWN) GUIDE RAIL BELL LINE UNDER GROUNG GAS LINE

AP

PROPOSED CATCHBASIN LOCATION AND OUTLET PIPE OVERHEAD HYDRO AND POLE HYDRO POLE (TO MOVE IF X) ANCHOR POLE (TO MOVE IF X)

CROSS-SECTION LOCATION IN FIELD AREAS IT IS LIMIT OF TOPSOIL STRIPPING

PLAN LEGEND

APPROXIMATE LOCATION AND SIZE OF EXISTING PIPE OR SLEEVE ACROSS DYKE ABOVE GRADE UNLESS NOTED AS BELOW GRADE (BG) A2 ETC. PROPOSED NEW IRRIGATION WORK

(SEE EXTENT OF WORK NOTES RE NEW IRRIGATION WORK) EXISTING WELL (SEE EXTENT OF WORK NOTES) - NEW CANAL BANK

ME ME ME ME ME ULTIMATE CHANNEL REQUIRED IF BRIDGE NOT REPLACED ---- PROPOSED LEVELLING AREA BOUNDARY PROPOSED TEMPORARY STRIPPED TOPSOIL STOCKPILE OR CLEARING BOUNDARY FOR LEVELLING

- PROPOSED BUFFER FULL FULL RELOCATION OF EXISTING CANAL PARTIAL PARTIAL RELOCATION OF EXISTING CANAL


ROW RIGHT-OF-WAY PIN PROPERTY IDENTIFICATION NUMBER


HOLLAND MARSH DRAINAGE SYSTEM CANAL IMPROVEMENT PROJECT HOLLAND MARSH DRAINAGE SYSTEM JOINT MUNICIPAL SERVICES BOARD TOWN OF BRADFORD WEST GWILLIMBURY COUNTY OF SIMCOE TOWNSHIP OF KING


AERIAL VIEW OF PROPERTIES AND EXTENT OF WORK NOTES



JOB NUMBER 03-023 ANUARY, 2009 DRAWING NUMBE 24

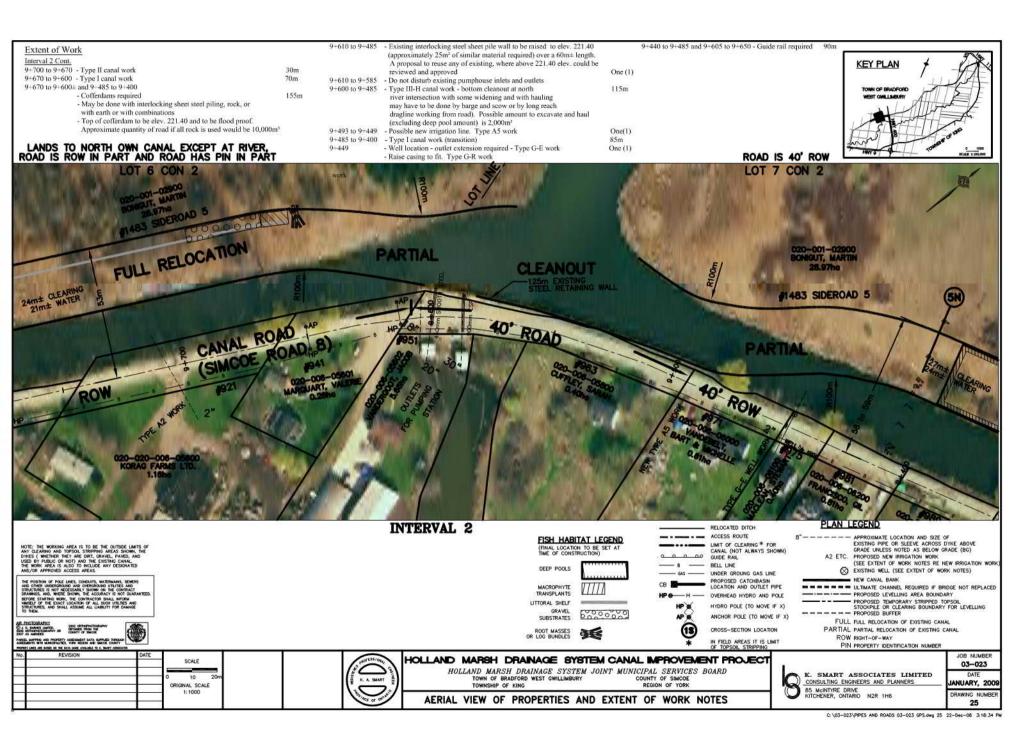

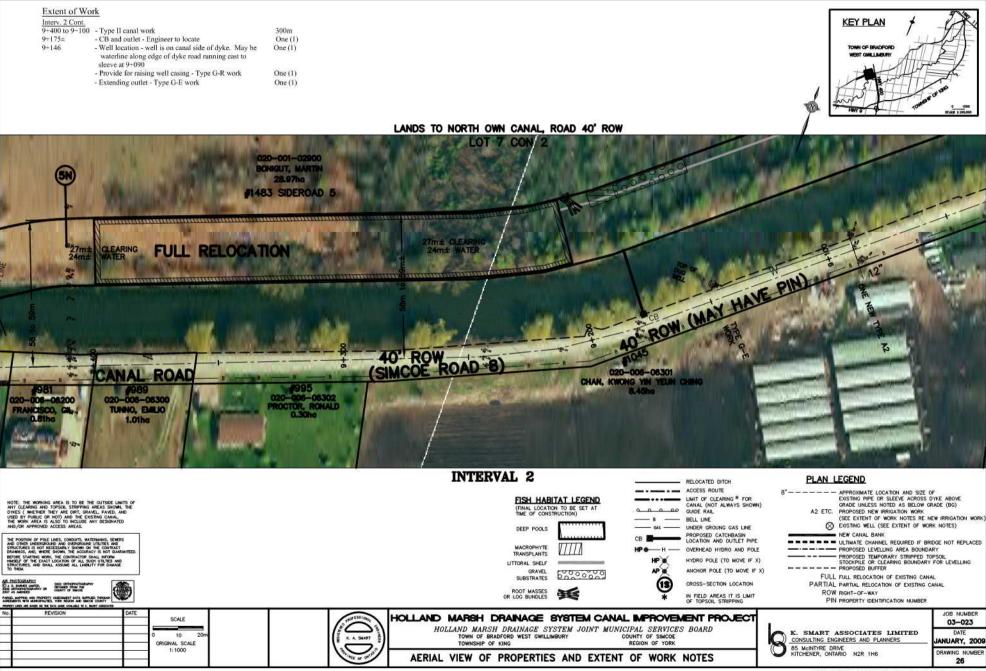

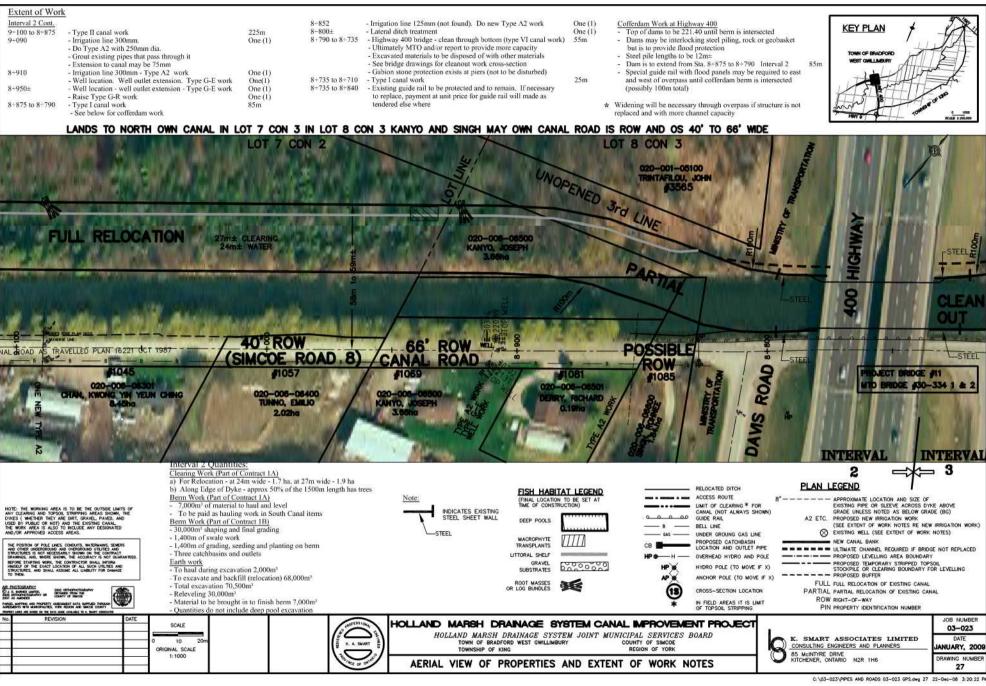

Extent of Work Interval 3 8+710 to 8+610 8+610 to 8+360 8-620 & 8+568 8+550 8+507 8+469 & 8+474 8+447	- Type I canal work - Type II canal work - Type II canal work - Irrigation lines - 2 - 250mm. Do one Type A2 work - CB and outlet - Engineer to locate - Irrigation line 200mm - Do Type A2 work - Irrigation lines - 2 - 50mm not used - no work - Irrigation lines - 2 - 50mm not used - no work	8+700 to 8+650 8+700 to 8+732 250m One (1) 8+710 One (1) 8+600± One (1) 8+420	5 - Existing guide rail to remain and to be protected. If necessary to replace, payment would be made at unit price for guide rail as tendered elsewhere - Lateral channel treatment - Canal side well location (not found). Do Type G-E ext work and raise casing - Type G-R work - Relocate existing hydro pole, adjust hydro line	One (1) - One (1) - One (1)	offerdam Work at Highway 400 Top of dams to be 221.40 until berm is intersected Dams may be interlocking steel piling, rock or geobasket but is to provide flood protection Steel pile lengths to be 12m± Dam is to extend from 8+610 to 8-710 Interval 3 Special guide rail with flood panels may be required to east and west of overpass until cofferdam berm is intersected (possibly 100m total)	TOWN OF BNJOPONO WEST GRALLEGARY			
	CANAL HAS SEPARATE PIN, ROAD IS EITHER SEPARATE PIN OR A ROW — IS 66' WIDE								
			LOT 8 C 020-005-00200 0ERICOLA, AMEDIED 70.4ho 43399 LINE 4						
IGHWAY	THE		FULL RELOCA	TION	27m± CLEARING 24m± WATER				
400	PARTIAL	Allow							
Sec. DOM OD BIN									
	TEEL 6 ,	- B - B - B - B	66', ROW, OR PIN	8 7	0 0 0 0 0 0 0 0 0 0 0 0 0 0 0 0 0 0 0 0	Trempos pour			
	WST ROAD ON THE STATE OF THE ST	TO LINE	020-006-06900 ON 70° ONE A4 8*	SINGH, RAKU	8" 78 00 42 80 07000 MAR & ROHNEE 22ha SNGH, RANGHAR & RO	(SIMCOE ROAD 8) #1189 020-008-07200 90RZO, PROSKA 2.85ha			
			INTERVAL 3	À	RELOCATED DITCH ACCESS ROUTE 8"—	PLAN LEGEND APPROXIMATE LOCATION AND SIZE OF			
NOTE: THE WORKING AIREA IS ANY CLEARING AIRD TOPSOLS ON THE THE THEY ARE USED BY PUBLIC OR NOT) AIR THE WORK AIREA IS ALSO AIRD AIR POSTRON OF POLE LINES, OF AIR OTHER WORKENS IS NOT NECESSARE, DRAWNOS, AND, WEST STATEMENT, AND THE AIR AIR AND THE AIR AIR AND THE AIR AIR AIR AIR AND THE AIR	TO BE THE OUTSIDE LIMITS OF THE PROPERTY AND ALLAS SHOWN, THE THE PROPERTY AND ALLAS SHOWN, THE PROPERTY AND ALLAS SHOWN, THE PROPERTY AND ALLAS SHOWN AND ALL		Note: INDICATES EXISTING STEEL SHEET WALL	ISH HABITAT LEGEN FINAL LOCATION TO BE SET A ME OF CONSTRUCTION) BEEP POOLS ACROPHYTE	ND LIMIT OF CLEARING * FOR	APPROUMATE COLORINA AND SIZE OF ENSINING PIPE CO RICENE AROUSE ABOVE GRADE UNLESS NOTED AS BELLOW GRADE (BG) A2 ETC. PROPOSED NEW IRRICATION WORK (SEE EXTENT OF WORK NOTES RE NEW IRRICATION WORK) SUSTING WELL (SEE EXTENT OF WORK NOTES) NEW CANAL BANK ULTIMATE CHANNEL REQUIRED IF BRIDGE NOT REPLACED PROPOSED LEVELLING AREA BOUNDARY			
BEFORE STARTING WORK, THE CO- HINSELF OF THE EXACT LOCATION STRUCTURES, AND SHALL ASSUM TO THEM.	INTRACTOR SHALL INFORM OF ALL SUCH UTLITES AND E ALL LIABILITY FOR CAMAGE			ANSPLANTS LLLLLI PRAL SHEUF GRAVEL	HP) HYDRO POLE (TO MOVE IF X)	PROPOSED TEMPORARY STRIPPED TOPSOIL STOCKPILE OR CLEARING BOUNDARY FOR LEVELLING PROPOSED BUFFER			
ASE PHOTOGRAPHY © 1 to saved users, See orthogologically of South and Management of Parect users as well as the country of ASE ASE ASE ASE ASE ASE AS THE COUNTRY OF ASE AS ASSESSED TO THE ASE ASSESSED TO THE ASE ASSESSED TO THE OWNER ASE ASSESSED THE ASE ASSESSED THE DATA MANAGE AS	MARKE TO K SHAPE ASSOCIATE		RO	GRAVEL DOGO O O O O O O O O O O O O O O O O O	TOPSOUS TRIPPING * NORTH POLICE (TO MOVE IF X) * CROSS-SECTION LOCATION * FIELD AREAS IT IS LIMIT OF TOPSOUS STRIPPING	FULL FULL RELOCATION OF EXISTING CANAL PARTIAL PARTIAL RELOCATION OF EXISTING CANAL ROW RIGHT-OF-WAY PIN PROPERTY IDENTIFICATION NUMBER			
No. REVISION	DATE SCALE	67	HOLLAND MARSH DRAINAG			JOB NUMBER 03-023			

10

ORIGINAL SCALE 1:1000


HOLLAND MARSH DRAINAGE SYSTEM JOINT MUNICIPAL SERVICES BOARD TOWN OF BRAFORD WEST GWILLIMBURY COUNTY OF SIMCOB TOWNSHIP OF KINO REGION OF YORK


AERIAL VIEW OF PROPERTIES AND EXTENT OF WORK NOTES


K. SMART ASSOCIATES LIMITED
CONSULTING ENGINEERS AND PLANNERS
85 M-INTYRE DRIVE
RITCHENER, ONTARIO N2R 1H6


JANUARY, 2009


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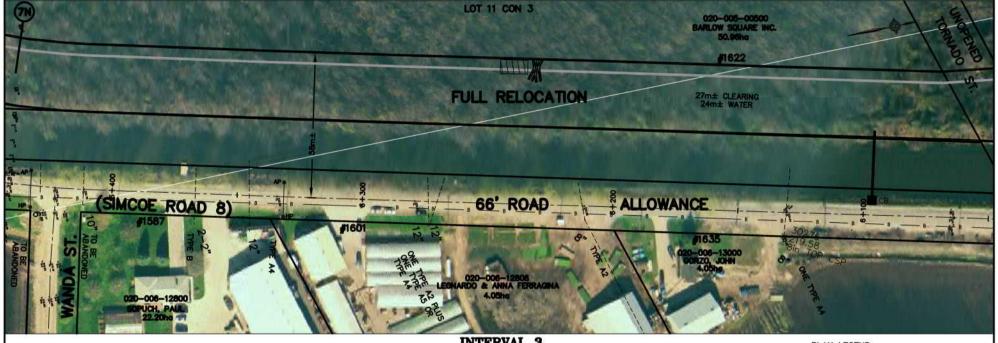


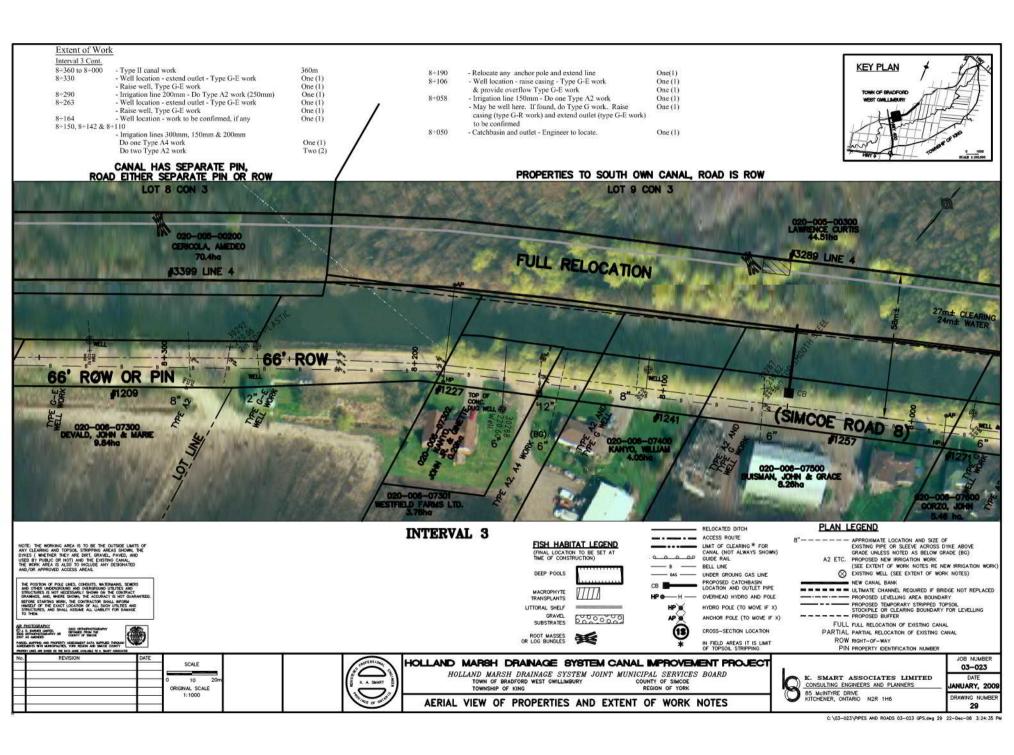Extent of Work Interval 3 Cont. 6+440 to 6+050 - Type II canal work 390m 6+430 - Irrigation line 150mm - abandon existing (seal) One (1) - Irrigation line 250mm - abandon existing (seal) 6+413 One (1) 6+368 - Irrigation line, 2 - 50mm - Do Type B work Two (2) 6+346 - Irrigation line 300mm - Do Type A4 work One (1) 6+274 - Irrigation line 300mm - Do Type A2* work One (1) - Irrigation line 300mm - Do Type A5* work 6+268 One (1) 6+213 - Irrigation line 200mm - Do Type A2 work One (1) 6+130 - Irrigation line 200mm - Do Type A4 work One (1) (since one at 6+035 is to be abandoned/sealed) One (1) 6+100± - CB and outlet - Engineer to locate One (1)

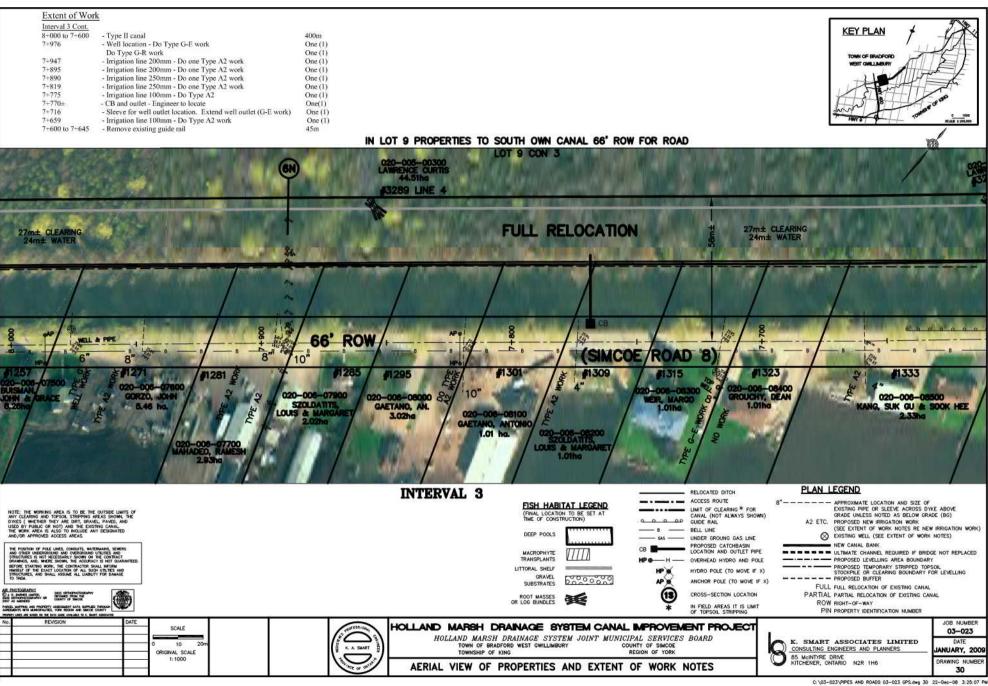* One type A4 could be done to replace the two of these. Decision to be made at time of constuction.

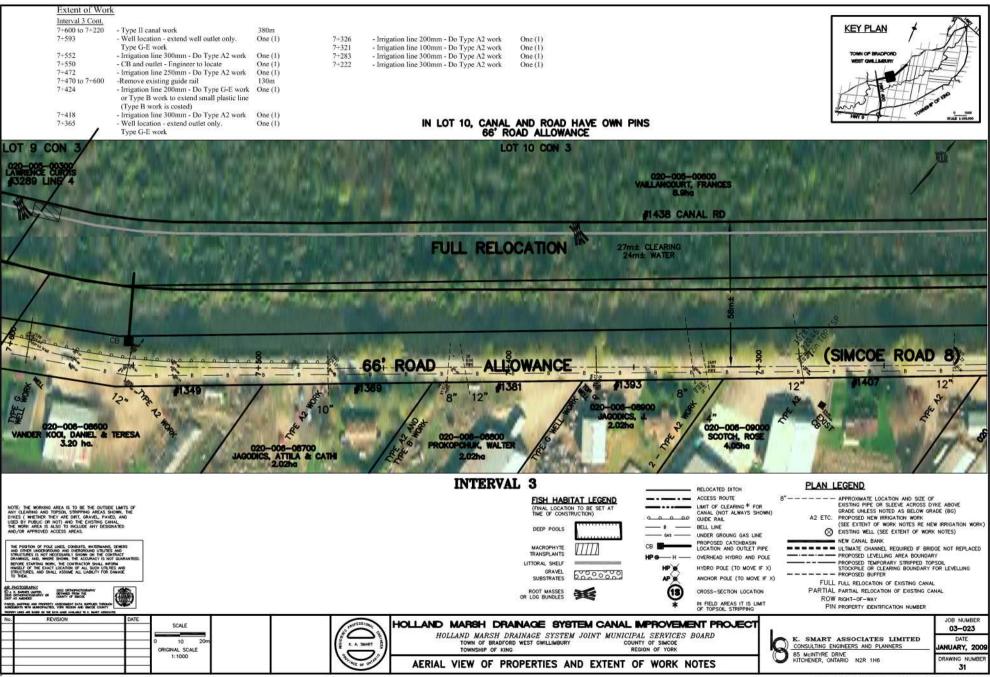

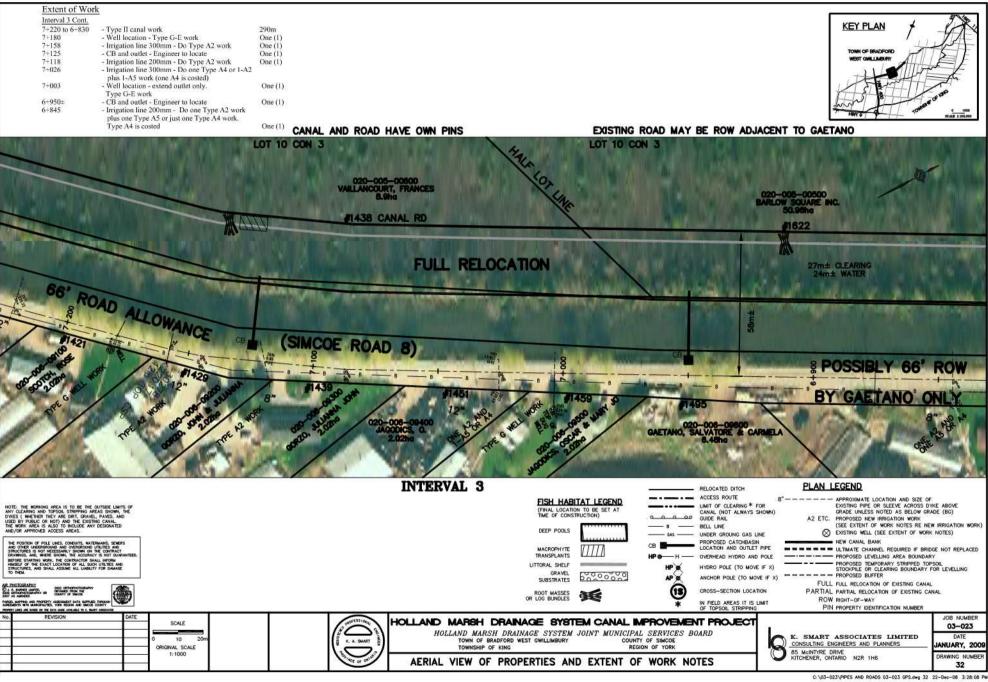IN LOT 11 SEPARATE PINS FOR CANAL AND ROAD 66' ROAD ALLOWANCE

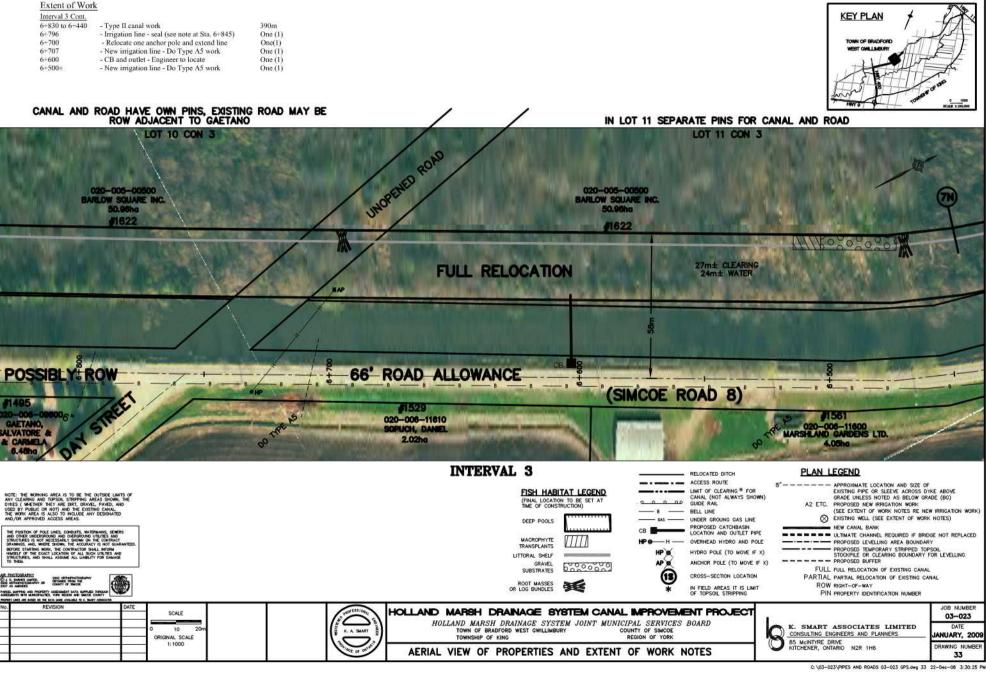



INTERVAL 3

TOWN OF BRADFORD WEST GWILLIMBURY TOWNSHIP OF KING

NOTE: THE WORKING AREA IS TO BE THE OUTSIDE LIMITS OF ANY CLEARING AND TOPSOL STREPPING AREAS SHOWN. THE DIVES (WHETHER THEY ARE DRY, GRAVEL, FAVED, AND USED BY PUBLIC OR NOT) AND THE EXISTING CANAL. THE WORK AREA IS ALSO TO INCLUDE ANY DESIGNATED AND/OR APPROVED ACCESS AREAS.

TED. DET OF SHOW THE PARCEL MAPPING AND PROPERTY ASSESSMENT DATA SUPPLIED THROUGH ADMITMENTS WITH MASSESSMENTS, YORK REGION AND SMOOT COUNTY

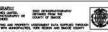

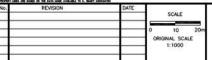



FISH HABITAT LEGEND (FINAL LOCATION TO BE SET AT TIME OF CONSTRUCTION)

DEEP POOLS MACROPHYTE TRANSPLANTS LITTORAL SHELF

CRAVEL 5000000 SUBSTRATES

HOLLAND MARSH DRAINAGE SYSTEM CANAL IMPROVEMENT PROJECT

HOLLAND MARSH DRAINAGE SYSTEM JOINT MUNICIPAL SERVICES BOARD

RELOCATED DITCH ACCESS ROUTE LIMIT OF CLEARING * FOR CANAL (NOT ALWAYS SHOWN) GUIDE RAIL

(3)

COUNTY OF SIMCOE

REGION OF YORK

BELL LINE UNDER GROUNG GAS LINE PROPOSED CATCHBASIN LOCATION AND OUTLET PIPE

OVERHEAD HYDRO AND POLE HYDRO POLE (TO MOVE IF X) ANCHOR POLE (TO MOVE IF X)

CROSS-SECTION LOCATION IN FIELD AREAS IT IS LIMIT OF TOPSOIL STRIPPING

PLAN LEGEND

APPROXIMATE LOCATION AND SIZE OF EXISTING PIPE OR SLEEVE ACROSS DYKE ABOVE GRADE UNLESS NOTED AS BELOW GRADE (BG)

A2 ETC. PROPOSED NEW IRRIGATION WORK
(SEE EXTENT OF WORK NOTES RE NEW IRRIGATION WORK EXISTING WELL (SEE EXTENT OF WORK NOTES)

MEW CANAL BANK

- - - - - ULTIMATE CHANNEL REQUIRED IF BRIDGE NOT REPLACED ---- PROPOSED LEVELLING AREA BOUNDARY PROPOSED TEMPORARY STRIPPED TOPSOIL STOCKPILE OR CLEARING BOUNDARY FOR LEVELLING --- PROPOSED BUFFER

FULL FULL RELOCATION OF EXISTING CANAL PARTIAL PARTIAL RELOCATION OF EXISTING CANAL ROW RIGHT-OF-WAY

PIN PROPERTY IDENTIFICATION NUMBER

03-023 K. SMART ASSOCIATES LIMITED CONSULTING ENGINEERS AND PLANNERS ANUARY, 2009 85 McINTYRE DRIVE KITCHENER, ONTARIO N2R 1H6 DRAWING NUMBE

AERIAL VIEW OF PROPERTIES AND EXTENT OF WORK NOTES

JOB NUMBER

DATE

Interval 3 Cont.

6+030

6+050 to 5+660 - Type II canal 6+035


- Irrigation line 300mm - to be abandoned

6+009 - Irrigation line 50mm - Do Type B work 5+794

- Anchor pole to relocate and extend line

One (1) - Irrigation line 250mm - Do Type A4 work One (1) One (1)

One (1)

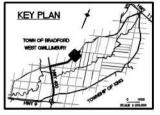

IN LOT 11 & 12 SEPARATE PINS FOR CANAL AND ROAD, TOWN OWNS 100' ADJACENT (EXCEPT FOR ONE LOT) LOT 11 CON 4 1033 FULL RELOCATION JOME CLEARING 66' ROAD ALLOWANCE SIMCOE ROAD 8

INTERVAL 3

FISH HABITAT LEGEND (FINAL LOCATION TO BE SET AT TIME OF CONSTRUCTION)

DEEP POOLS MACROPHYTE TRANSPLANTS

LITTORAL SHELF

GRAVEL

SUBSTRATES

600000 ROOT MASSES OR LOG BUNDLES

ACCESS ROUTE LIMIT OF CLEARING * FOR CANAL (NOT ALWAYS SHOWN) GUIDE RAIL BELL LINE UNDER GROUNG GAS LINE PROPOSED CATCHBASIN LOCATION AND OUTLET PIPE OVERHEAD HYDRO AND POLE

RELOCATED DITCH

HYDRO POLE (TO MOVE IF X) ANCHOR POLE (TO MOVE IF X) CROSS-SECTION LOCATION IN FIELD AREAS IT IS LIMIT OF TOPSOIL STRIPPING

PLAN LEGEND

APPROXIMATE LOCATION AND SIZE OF EXISTING PIPE OR SLEEVE ACROSS DYKE ABOVE GRADE UNLESS NOTED AS BELOW GRADE (BG) A2 ETC. PROPOSED NEW IRRIGATION WORK (SEE EXTENT OF WORK NOTES RE NEW IRRIGATION WORK)

EXISTING WELL (SEE EXTENT OF WORK NOTES) - NEW CANAL BANK MINING MINING THE MANUEL REQUIRED IF BRIDGE NOT REPLACED

---- PROPOSED LEVELLING AREA BOUNDARY PROPOSED TEMPORARY STRIPPED TOPSOIL STOCKPILE OR CLEARING BOUNDARY FOR LEVELLING - - PROPOSED BUFFER

FULL FULL RELOCATION OF EXISTING CANAL PARTIAL PARTIAL RELOCATION OF EXISTING CANAL ROW RIGHT-OF-WAY

PIN PROPERTY IDENTIFICATION NUMBER

PROPERLY LINES AND BASED ON THE EXIST MADE AND AREE TO A. SMART ADDRESSES						
No.	REVISION	DATE	SCALE			
			0 10 20m			
88			ORIGINAL SCALE 1:1000			
			1			

NOTE: THE MODRING AREA IS TO BE THE OUTSIDE LIMITS OF ANY CLEAPING AND TOPSOL STREPPING AREAS SHOWN, THE DYDICS ("METHER THEY ARE DET, GRAVE). PAVED, AND USED BY PUBLIC OR NOT) AND THE DISTRIP CANAL. THE WORK AREA IS ALSO TO INCLUDE ANY DESIGNATED AND/OR APPROVED ACCESS AREAS.



HOLLAND MARSH DRAINAGE SYSTEM CANAL IMPROVEMENT PROJECT

HOLLAND MARSH DRAINAGE SYSTEM JOINT MUNICIPAL SERVICES BOARD TOWN OF BRADFORD WEST GWILLIMBURY COUNTY OF SIMCOE TOWNSHIP OF KING

AERIAL VIEW OF PROPERTIES AND EXTENT OF WORK NOTES



K. SMART ASSOCIATES LIMITED CONSULTING ENGINEERS AND PLANNERS

JOB NUMBER 03-023 ANUARY, 2009 DRAWING NUMBE 35

Extent of Work Interval 3 Cont. 5+660 to 5+260 - Type II canal work 400m - CB and outlet - Engineer to locate 5+550± One (1) 5+522 - Irrigation line 200mm - Do Type A2 work One (1) 5+435 - Irrigation line 200mm - Do Type A2 work One (1) 5+310 - Irrigation line 200mm - Do Type A2 work One (1)

5+260 to 5+435 - Remove guide rail

Interval 3 Quantities: Clearing Work (Part of Contract 2A)

a) For Restoration - 10.3 ha

b) Along Dyke - approximately 25% of the 3,700m length has trees Berm Work (Part of Contract 2A)

 20,000m³ additional material to be brought in and graded and paid as hauling work in South Canal

Berm Work (Part of Contract 2B)

- 85,000m² shaping and final grading (would be 10,000m³± of material

to push into berm)
- 3.422m of swale work

175m

- 3,422m seeding and planting on berm

- Nine catchbasins and outlets

Earth work

- To excavate and backfill (relocation) 203,500m3
- Total excavation 203,500m³
- Releveling 85,000m²
- Final leveling 7,000m²
 Material to be brought in to finish berm 20,000m³
- Quantities do not include deep pool excavation





SIMCOE ROAD 8)

FULL RELOCATION

Some CEARNING
24mm WATER

(SIMCOE ROAD 8)

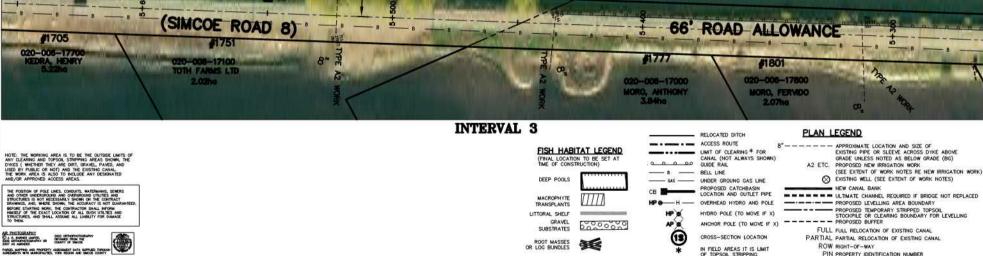

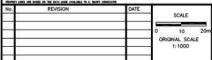



HOLLAND MARSH DRAINAGE SYSTEM CANAL IMPROVEMENT PROJECT

HOLLAND MARSH DRAINAGE SYSTEM JOINT MUNICIPAL SERVICES BOARD TOWN OF BRADFORD WEST GWILLIMBURY COUNTY OF SINCOE TOWNSHIP OF KING REGION OF YORK

AERIAL VIEW OF PROPERTIES AND EXTENT OF WORK NOTES



Extent of Work Interval 3 Cont. 5+260 to 4+982 - Type VIIA canal work 5+140 - Irrigation line 200mm - abandon - Irrigation line 200mm - Do Type A4 work 4+993 4+982 to 5+260 - Remove guide rail 5+110 to 5+160 - Relocate anchor pole and extend line

10

ORIGINAL SCALE

1:1000

278m

One (1)

One (1)

Two (2)

278m

Interval 4 (Part of Contract 2A and 2B)

- Type VIIA canal work - Irrigation line 200mm - abandon 4+082

- Irrigation line 200mm - Do Type A2 work 4+913 4+982 to 4+875 - Remove guide rail

HOLLAND MARSH DRAINAGE SYSTEM JOINT MUNICIPAL SERVICES BOARD

AERIAL VIEW OF PROPERTIES AND EXTENT OF WORK NOTES

COUNTY OF SIMCOE

TOWN OF BRADFORD WEST GWILLIMBURY

TOWNSHIP OF KING

162m One (1) One (1) 107m

KEY PLAN



85 McINTYRE DRIVE KITCHENER, ONTARIO


03-023

ANUARY, 2009

DRAWING NUMBE

37


Extent of Work Interval 4 Cont. 4+820 to 4-430 - Type VIIA canal work 4+795 - Irrigation line 200mm - abandon and seal One (1) 4+758 - Irrigation line 150mm - Do Type A4 work One (1) - CB and outlet - Engineer to locate 4+650 One (1) - Irrigation line 175mm - Do Type A4 work 4+532 One (1) 4+640 to 4+430 - Remove guide rail 210m - It is recommended where Canal Road is 4+750 to 4+550 resurfaced following construction that the road be raise by 250mm in the sag with tapering to match at ends of the 200m long portion IN LOT 11 & 12 SEPARATE PINS FOR CANAL AND ROAD, TOWN OWNS 100' ADJACENT (EXCEPT FOR ONE LOT) LOT 12 CON 4

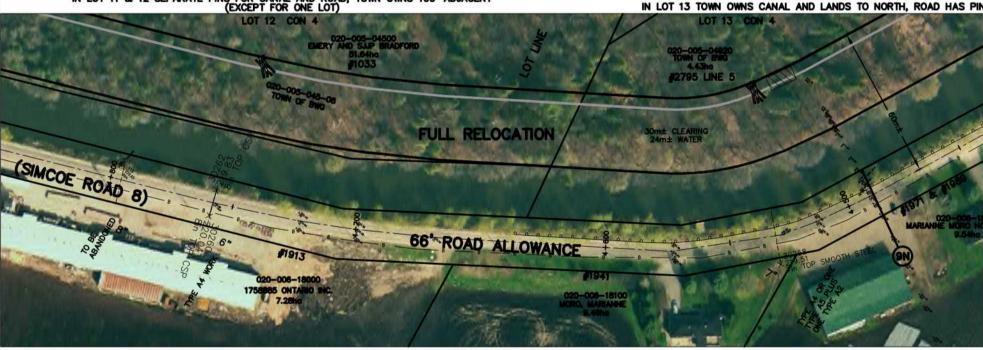

INTERVAL 4 PLAN LEGEND RELOCATED DITCH - - ACCESS ROUTE FISH HABITAT LEGEND LIMIT OF CLEARING * FOR CANAL (NOT ALWAYS SHOWN) (FINAL LOCATION TO BE SET AT TIME OF CONSTRUCTION)

© 4. S. SANSES LIMITED, SECTION OF SMOOT AS AMERICAN PARCEL MAPPING AND PROPERTY ASSESSMENT DATA SUPPLIED THROUGH ADMITMENTS WITH MASSESSMENTS, YORK REGION AND SMOOT COUNTY



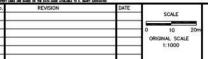



HOLLAND MARSH DRAINAGE SYSTEM CANAL IMPROVEMENT PROJECT

5000000

GUIDE RAIL

- UNDER GROUNG GAS LINE

PROPOSED CATCHBASIN LOCATION AND OUTLET PIPE

OVERHEAD HYDRO AND POLE

HYDRO POLE (TO MOVE IF X)

CROSS-SECTION LOCATION

IN FIELD AREAS IT IS LIMIT OF TOPSOIL STRIPPING

ANCHOR POLE (TO MOVE IF X)

- BELL LINE

HOLLAND MARSH DRAINAGE SYSTEM JOINT MUNICIPAL SERVICES BOARD TOWN OF BRADFORD WEST GWILLIMBURY TOWNSHIP OF KING COUNTY OF SIMCOE REGION OF YORK

AERIAL VIEW OF PROPERTIES AND EXTENT OF WORK NOTES

DEEP POOLS

MACROPHYTE TRANSPLANTS

GRAVEL

SUBSTRATES

LITTORAL SHELF

ROOT MASSES OR LOG BUNDLES

APPROXIMATE LOCATION AND SIZE OF EXISTING PIPE OR SLEEVE ACROSS DYKE ABOVE GRADE UNLESS NOTED AS BELOW GRADE (BG) PROPOSED NEW IRRIGATION WORK (SEE EXTENT OF WORK NOTES RE NEW IRRIGATION WORK)

KEY PLAN

EXISTING WELL (SEE EXTENT OF WORK NOTES) - NEW CANAL BANK

--- PROPOSED LEVELLING AREA BOUNDARY PROPOSED TEMPORARY STRIPPED TOPSOIL STOCKPILE OR CLEARING BOUNDARY FOR LEVELLING


--- PROPOSED BUFFER FULL FULL RELOCATION OF EXISTING CANAL PARTIAL PARTIAL RELOCATION OF EXISTING CANAL


ROW RIGHT-OF-WAY PIN PROPERTY IDENTIFICATION NUMBER

K. SMART ASSOCIATES LIMITED CONSULTING ENGINEERS AND PLANNERS 85 McINTYRE DRIVE KITCHENER, ONTARIO N2R 1H6


JOB NUMBER 03-023 DATE ANUARY, 2009 DRAWING NUMBE 38

Extent of Work Interval 4 Cont. 4+195 to 4+150 - Construct 45m cofferdam cofferdam on east side of old cut* 45m Work to blend to existing bridge if necessary See Bridge drawing which shows 3 extra cofferdams, temporary KEY PLAN 4+138 & 4+128 - New bridge to be constructed (5th Line) by Town 4+440± to 4+140± - Clear 15m path west of old abandoned channel 0.5 ha and between old abandoned channel and new in advance of canal work cleanout of 110m, cleanout of bridge, filling in of two notches Riprap lateral channels (50m³ rock and filter) channel and then 15m west of (approximately 0.5 ha) with riprap to be provided if old bridge not replaced in advance. - Fill in old abandoned channel (approx. 2,500m³) - Match new channel to new bridge cut * One (1) Also detail construction drawings would be necessary if old 4+430 to 4+138 - Type VIIA canal work 292m bridge were to be retained and joined into Interval 5 (Part of Contract 2A) 4+388 - Irrigation line 200mm - Do Type A2 work One (1) 4+372 - Irrigation line 100mm - Do Type A2 work 4+128 to 4+050 - Type VIIA canal work One (1) 4+362 - Irrigation line 250mm - Do Type A2 work 4+051 - Irrigation line 100mm - Do Type A2 work One (1) One (1) 4+260 to 4+200 - Construct 60m cofferdam on west side of old cut * - Probably just 50mm extension 60m 4+430 to 4+138 - Remove guide rail 292m 4+128 to 4+050 - Remove guide rail 78m * This is on the basis new bridge exists prior to construction TOWN OWNS CANAL AND LANDS TO NORTH ROAD HAS A PIN (See note this drawing) LOT 13 CON 4 2795 LINE 5 30m± CLEARING 24m± WATER **FULL RELOCATION** 66' ROAD ALLOWANCE #2023 020-008-15200 SEVA. ARMANDO & MARIA INTERVAL RELOCATED DITCH, PLAN LEGEND ---- ACCESS ROUTE Interval 4 Quantities: APPROXIMATE LOCATION AND SIZE OF FISH HABITAT LEGEND LIMIT OF CLEARING * FOR Clearing Work (Part of Contract 2A) EXISTING PIPE OR SLEEVE ACROSS DYKE ABOVE GRADE UNLESS NOTED AS BELOW GRADE (BG) CANAL (NOT ALWAYS SHOWN) (FINAL LOCATION TO BE SET AT TIME OF CONSTRUCTION) a) For relocation - 3.0 ha (including outside old canal) GUIDE RAIL A2 ETC. PROPOSED NEW IRRIGATION WORK b) Along dyke - Approximately 50% of the 850m length has trees BELL LINE (SEE EXTENT OF WORK NOTES RE NEW IRRIGATION WORK) Earth work DEEP POOLS UNDER GROUNG GAS LINE EXISTING WELL (SEE EXTENT OF WORK NOTES) - To excavate and backfill (relocations) 50,000m² PROPOSED CATCHBASIN LOCATION AND OUTLET PIPE NEW CANAL BANK Total excavation 50,000m² ■■■■■■ ULTIMATE CHANNEL REQUIRED IF BRIDGE NOT REPLACED MACROPHYTE OVERHEAD HYDRO AND POLE - Final leveling 20,000m2 TRANSPLANTS ---- PROPOSED LEVELLING AREA BOUNDARY - Quantities do not include deep pool excavation HYDRO POLE (TO MOVE IF X) PROPOSED TEMPORARY STRIPPED TOPSOIL. STOCKPILE OR CLEARING BOUNDARY FOR LEVELLING PROPOSED BUFFER LITTORAL SHELF GRAVEL SUBSTRATES ANCHOR POLE (TO MOVE IF X) 000000 FULL FULL RELOCATION OF EXISTING CANAL (13) CROSS-SECTION LOCATION PARTIAL PARTIAL RELOCATION OF EXISTING CANAL ROOT MASSES OR LOG BUNDLES IN FIELD AREAS IT IS LIMIT OF TOPSOIL STRIPPING PARCE, MAPPING AND PROPERTY ASSESSMENT DATA SUPPLIED THROUGH AGRETACHTS WITH MANOPAUTES, YORK REGION AND SMICH COUNTY ROW RIGHT-OF-WAY PIN PROPERTY IDENTIFICATION NUMBER REVISION JOB NUMBER HOLLAND MARSH DRAINAGE SYSTEM CANAL IMPROVEMENT PROJECT SCALE 03-023 HOLLAND MARSH DRAINAGE SYSTEM JOINT MUNICIPAL SERVICES BOARD K. SMART ASSOCIATES LIMITED 10 TOWN OF BRADFORD WEST GWILLIMBURY COUNTY OF SIMCOE CONSULTING ENGINEERS AND PLANNERS ANUARY, 2009 ORIGINAL SCALE TOWNSHIP OF KING 85 McINTYRE DRIVE KITCHENER, ONTARIO 1:1000 DRAWING NUMBE AERIAL VIEW OF PROPERTIES AND EXTENT OF WORK NOTES 39

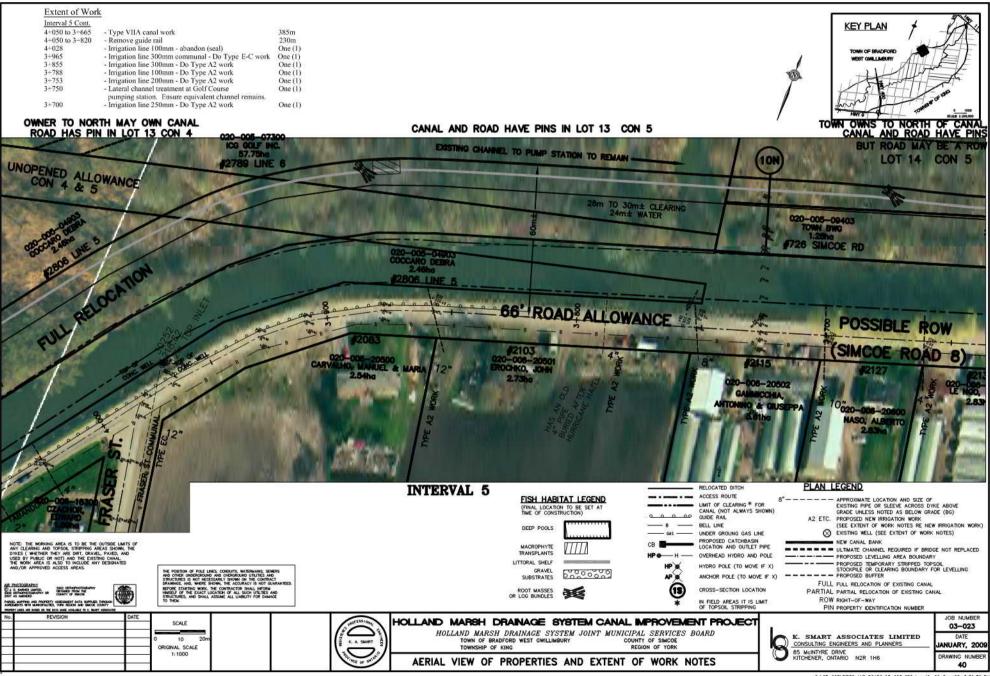

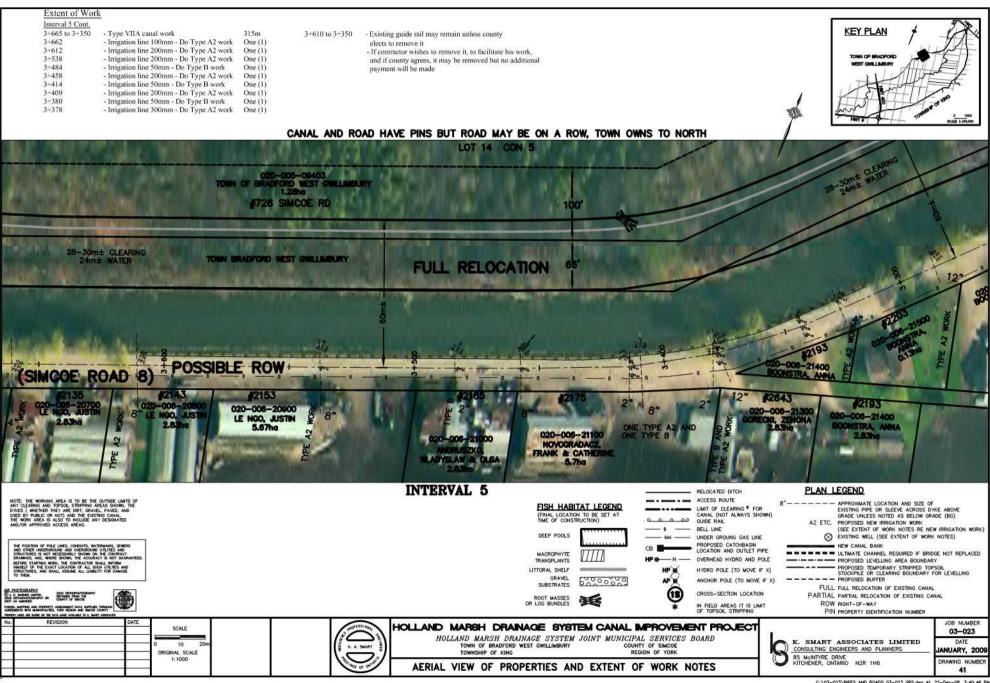

elects to rem - If contractor - and if county payment will 3+326 - Irrigation line 3+285 - Irrigation line 3+220 to 3+108 - Type I canal 3+202 - Irrigation line	e rail may remain unless county ve it visihes to remove it, to facilitate his work, agrees, it may be removed but no addition be made 100mm - Do Type A2 work 300mm - Do Type A2 work 400mm - Do Type A2 work	3+163 3+220 to 3+108 al One (1) 12m One (1) 12m One (1)	66' ROW I	ROAD HAVE PINS NORTH OF CANAL	TOWN OF BRADFORD WEST GMILLIBUSEY 1 100 SCALE 100,000
	020-005-09403 NN OF BRADFORD WEST GWILLIN 1.28ho 1.28ho RELOCATION 28-30 24	100'	C20-005-10001 RANJT, RAYMOND O.BONO F772 SIMCOE RD	PROJECT BRIDGE SINCOE COUNTY E	
CANAL	ROAD 92203	POSSIE 500 POSSIE 500 POSSIE 500 STRA BE	SUE ROW - 8" 8" 8" 82219 8" 82219 8" 82219 8" 82219 8" 8" 82219 8" 8" 82219 8" 8" 8" 8" 8" 8" 8" 8" 8" 8" 8" 8" 8"	8"	(OPTION 2) OLEANOUT OSMICOE ROAD B)
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Process owners are process; restrained units service interest. No. REVISION DATE NO. REVISION DATE	SCALE 0 10 20m CRIGINAL SCALE 1:1000	WINTERSTON, SERVICE OF THE PROPERTY OF THE PRO	PROOF MASSES PROOF	RINT MUNICIPAL SERVICES BOARD COUNTY OF SIMCOE REGION OF YORK	ROW RIGHT-OF-WAY PIN PROPERTY IDENTIFICATION NUMBER S. SMART ASSOCIATES LIMITED CONSULTING ENGINEERS AND PLANNERS BS. MENTING DRIVE RITCHENER, ONTARIO N2R 1H6 C. (33-023)PPES AND ROADS 03-023 OPS.dvg, 42 22-0e-08 3-41;33 PR

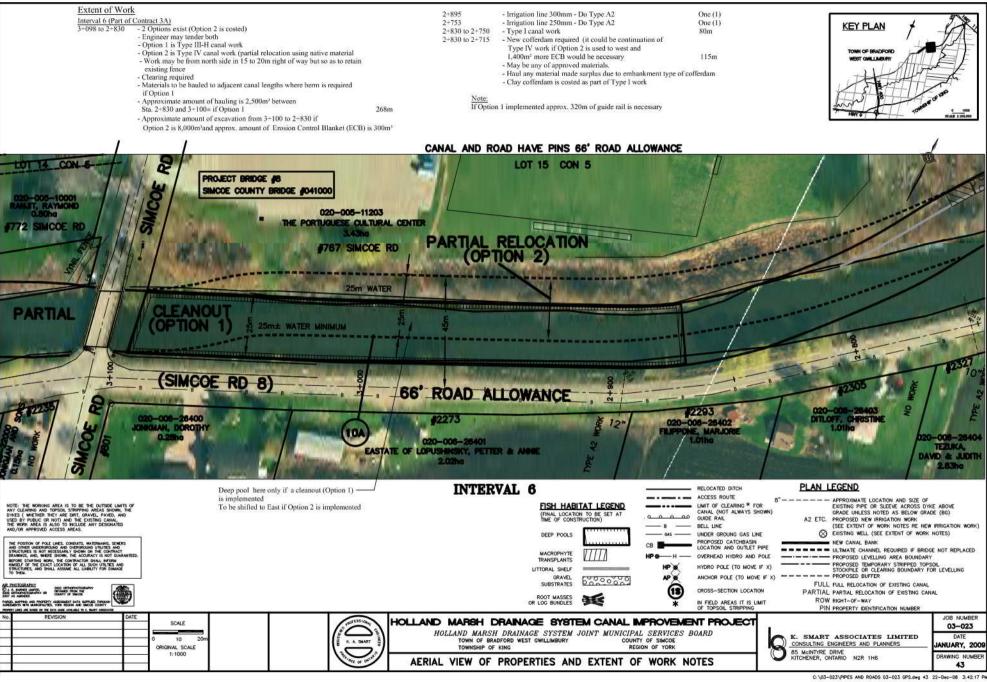

Interval 6 Cont.

2+750 to 2+715

2+715 to 2+400

2+494 2+505 to 2+400

- Type VIIA canal work

(see previous page for notes re cofferdams) 35m 315m - Irrigation line 150mm - Do Type A2 work One (1)

- Existing guide rail to remain unless County elects to remove it

10

ORIGINAL SCALE

1:1000

- Type I canal work

If contractor wishes to remove it, to facilitate his work, and if county agrees, it may be removed but no additional payment will be made

Interval 6 Quantities:

Clearing for Interval 6 (Part of Contract 3A)

- Clearing for relocation - 1.3 ha (if Option 2)

- Clearing along dyke - approx, 25% of the 698m length has trees but these

may remain wherever possible since no berm is required (if Option 1 is implemented)

- If Option 2 is implemented approx, 100m of length along dyke will be necessary to be cleaned

Earth work (No berm work to do)

- To excavate and backfill 33,500m²


- Total excavation 33,500m3

- Final leveling 20,000m²

- Quantities do not include deep pool excavation

KEY PLAN

CANAL AND ROAD HAVE PINS 66' ROAD ALLOWANCE

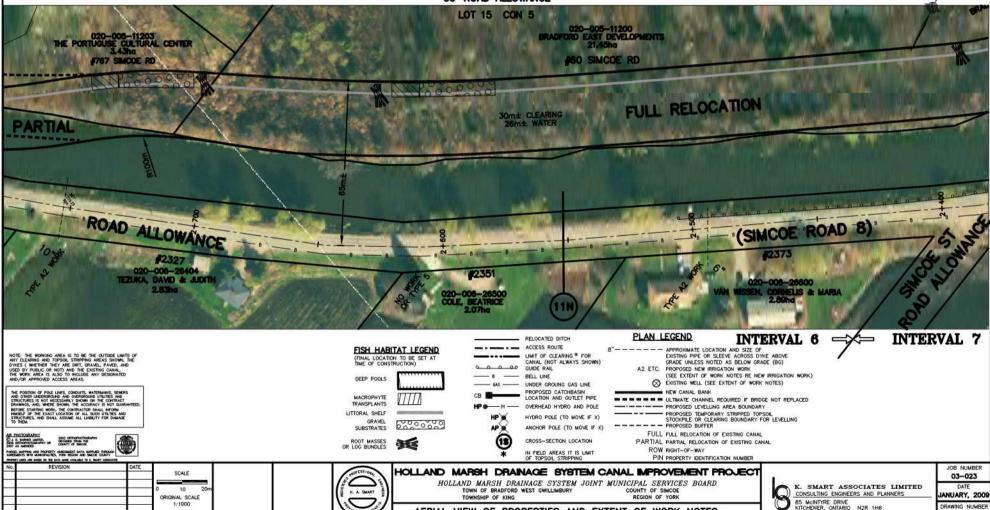

TOWN OF BRADFORD WEST GWILLIMBURY

AERIAL VIEW OF PROPERTIES AND EXTENT OF WORK NOTES


TOWNSHIP OF KING


COUNTY OF SIMCOE


85 McINTYRE DRIVE KITCHENER, ONTARIO


ANUARY, 2009


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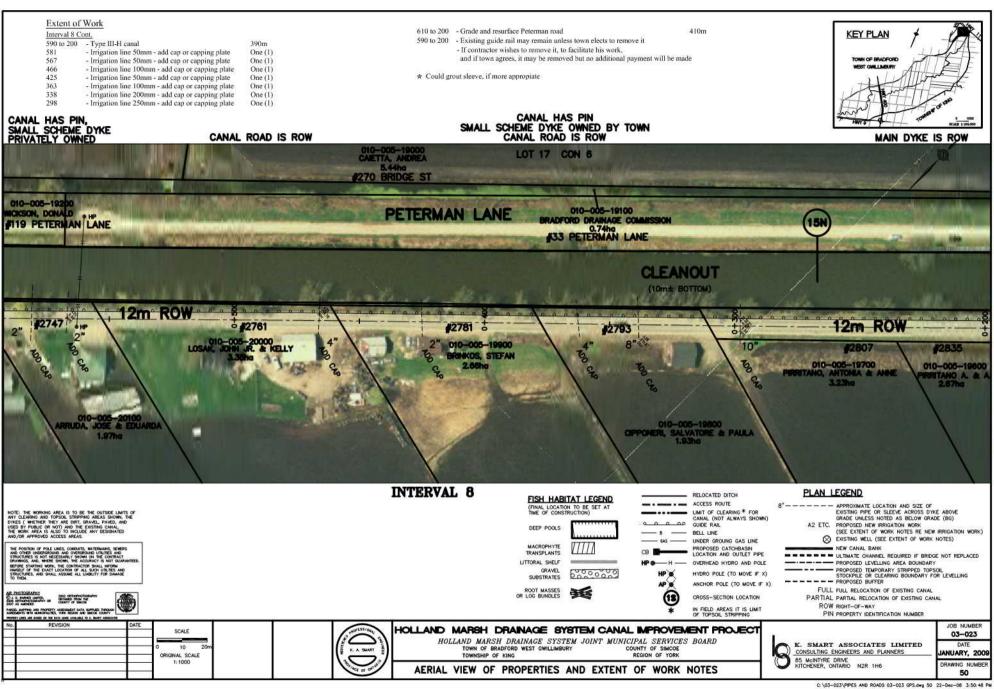


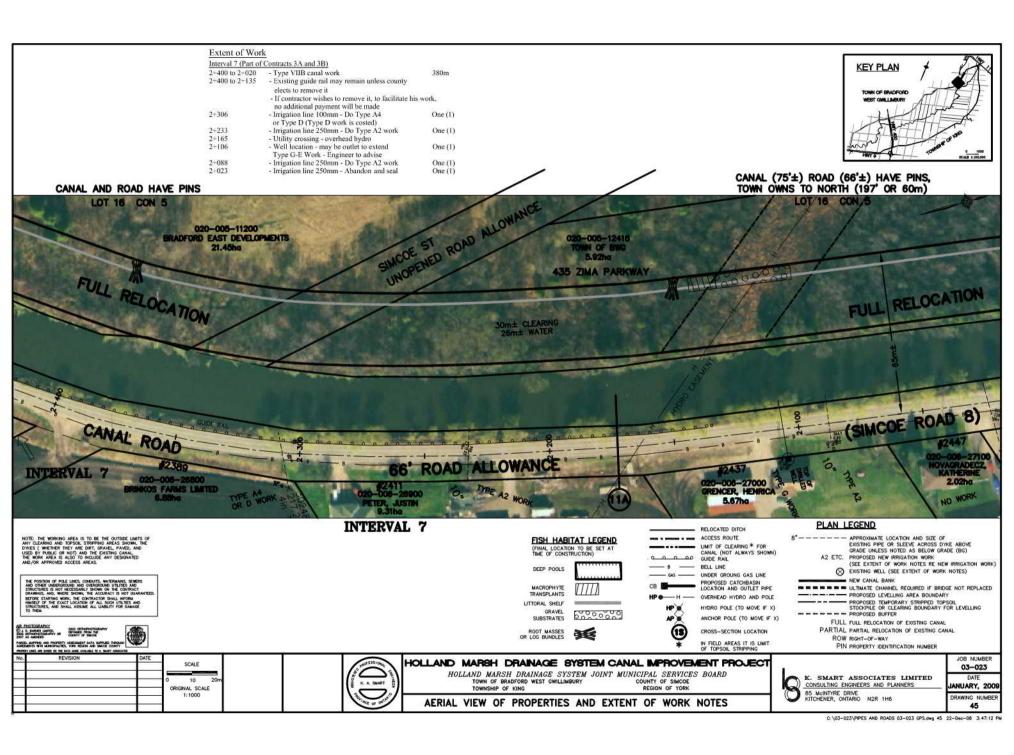

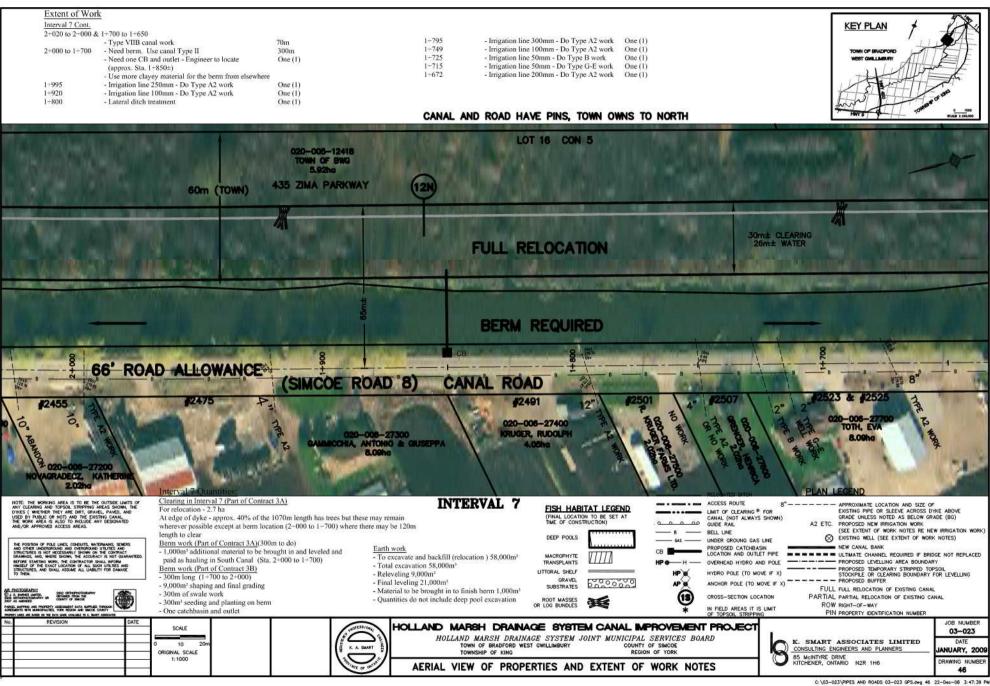

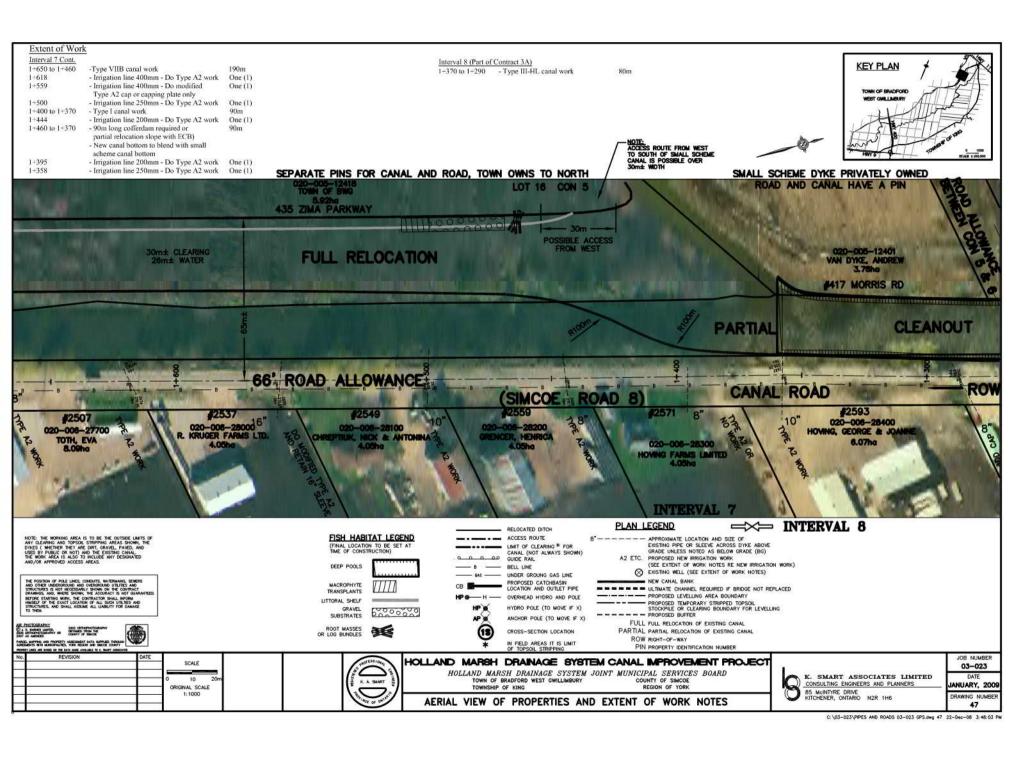


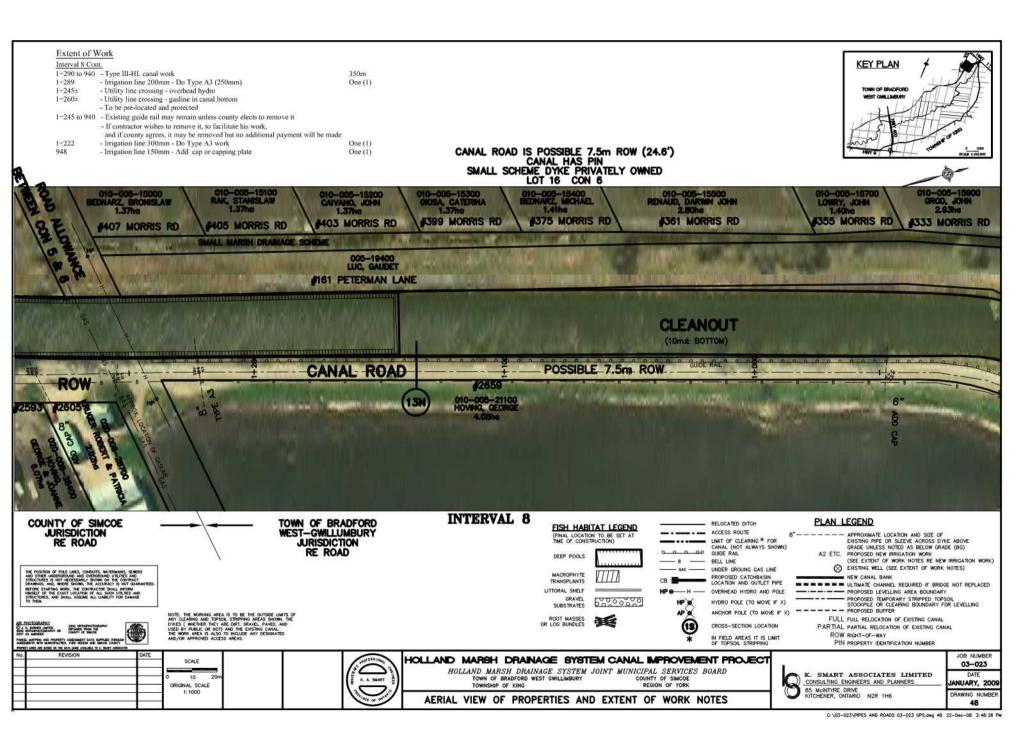

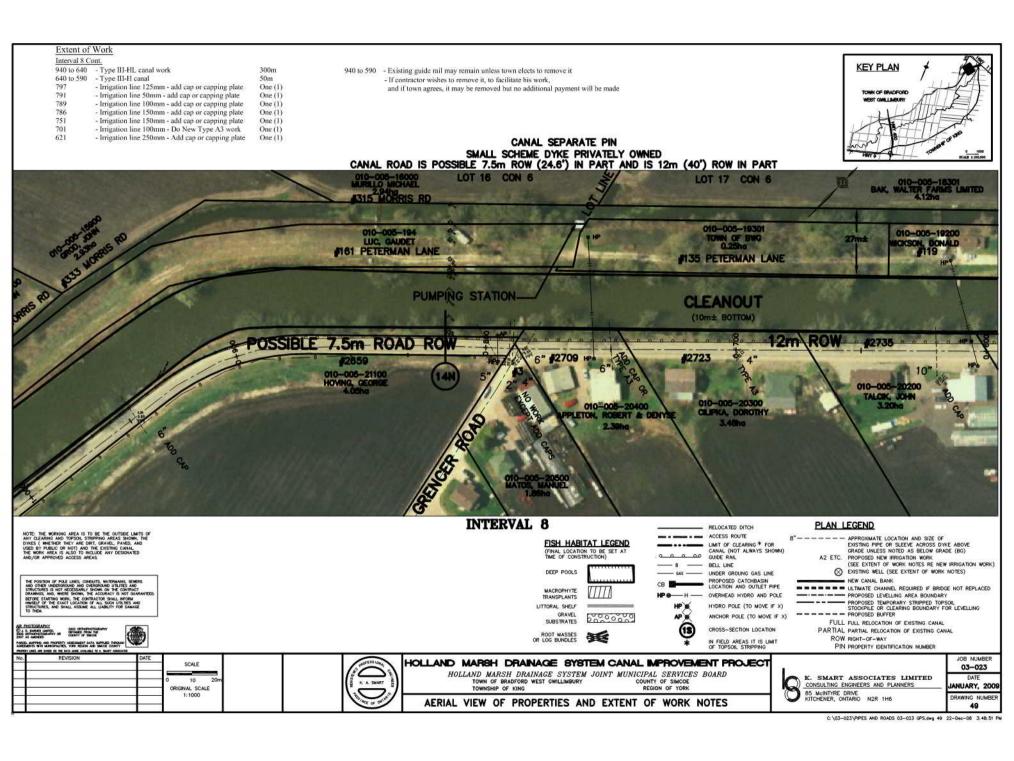



51

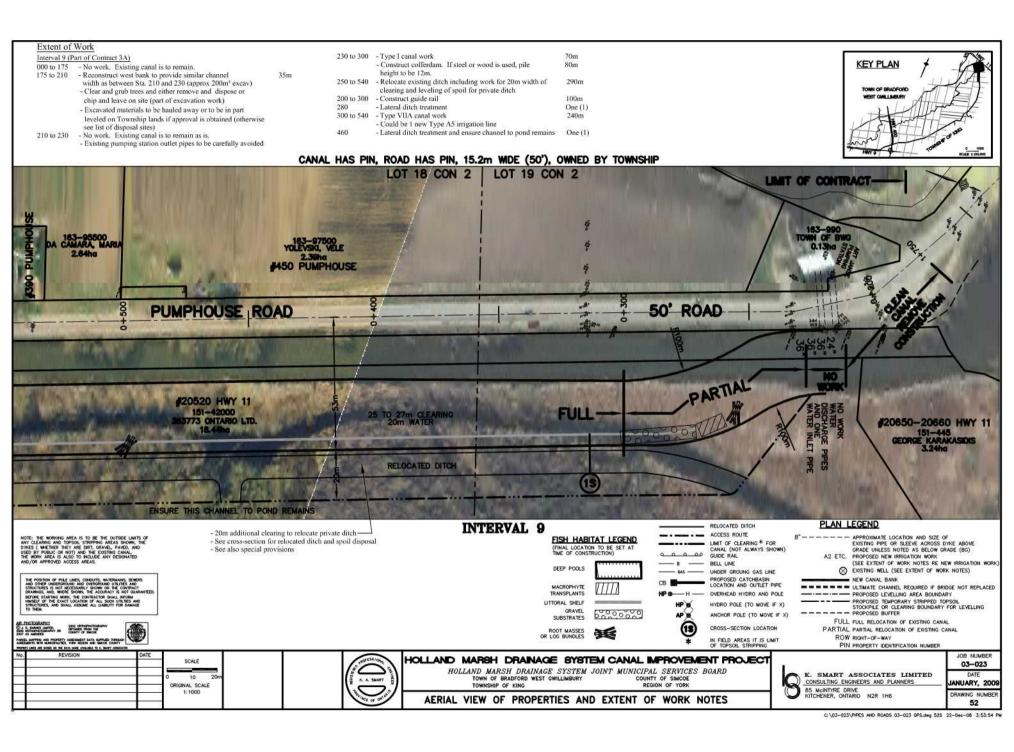

KEY PLAN Extent of Work Interval 9 Cont. 540 to 900 -Type VIIA canal work 540 to 900 - May be one new Type A5 irrigation line in this interval One (1) 615 - Lateral ditch treatment One (1) 620 - Carefully relocate pumping station for owner but One (1) if he does not want it, remove and dispose off site. 600 to 850 - 3m wide grass buffer required on east side of new canal - Relocate existing ditch including topsoil stripping and 340m 540 to 880 replacement and leveling of spoil CANAL HAS PIN, ROAD HAS PIN, 15.2m WIDE (50'), OWNED BY TOWNSHIP LOT 17 CON 2 LOT 18 CON 2 340 PUMPHOUSE 280 PUMPHOUSE #370 PUMPHOUSE 260 PUMPHOUSE 50' ROAD PUMPHOUSE ROAD #20400 HWY 1 **FULL RELOCATION** ECAR PROPERTIES LTD. RELOCATED DITCH INTERVAL 9 This section of ditch to be filled and PLAN LEGEND RELOCATED DITCH Tie relocated ditch into lateral ditch as shown abandoned FISH HABITAT LEGEND ACCESS ROUTE APPROXIMATE LOCATION AND SIZE OF NOTE: THE WONING AREA IS TO BE THE OUTSIDE UNITS OF ANY CLEARING AND TOPSOL STRIPPING AREAS SHOWN. THE DIVES (WHETHER THEY ARE DIET, GRAVE), AND USED BY PUBLIC OR NOT) AND THE EXISTING CANAL. THE WORK AREA IS ALSO TO INCLUDE ANY DESIGNATED AND/OR APPROVED ACCESS AREAS. LIMIT OF CLEARING * FOR EXISTING PIPE OR SLEEVE ACROSS DYKE ABOVE GRADE UNLESS NOTED AS BELOW GRADE (BG) - 20m width required for ditch relocation and levelling - Strip and replace topsoils GUIDE RAIL A2 ETC. PROPOSED NEW IRRIGATION WORK (SEE EXTENT OF WORK NOTES RE NEW IRRIGATION WORK) - See cross-sections and special provisions BELL LINE EXISTING WELL (SEE EXTENT OF WORK NOTES) UNDER GROUNG GAS LINE MACROPHYTE PROPOSED CATCHRASIN - NEW CANAL BANK LOCATION AND OUTLET PIPE - - - ULTIMATE CHANNEL REQUIRED IF BRIDGE NOT REPLACED TRANSPLANTS. - PROPOSED LEVELLING AREA BOUNDARY LITTORAL SHELF OVERHEAD HYDRO AND POLE PROPOSED TEMPORARY STRIPPED TOPSOIL STOCKPILE OR CLEARING BOUNDARY FOR LEVELLING HYDRO POLE (TO MOVE IF X) GRAVEL 500000 SUBSTRATES ANCHOR POLE (TO MOVE IF X) ----- PROPOSED BUFFER FULL FULL RELOCATION OF EXISTING CANAL ROOT MASSES OR LOG BUNDLES CROSS-SECTION LOCATION PARTIAL PARTIAL RELOCATION OF EXISTING CANAL ROW RIGHT-OF-WAY IN FIELD AREAS IT IS LIMIT OF TOPSOIL STRIPPING PIN PROPERTY IDENTIFICATION NUMBER REVISION JOB NUMBER HOLLAND MARSH DRAINAGE SYSTEM CANAL IMPROVEMENT PROJECT SCALE 03-023 HOLLAND MARSH DRAINAGE SYSTEM JOINT MUNICIPAL SERVICES BOARD K. SMART ASSOCIATES LIMITED 10 K. A. SMART TOWN OF BRADFORD WEST GWILLIMBURY COUNTY OF SIMCOE CONSULTING ENGINEERS AND PLANNERS ANUARY, 2009 ORIGINAL SCALE TOWNSHIP OF KING 1:1000 DRAWING NUMBE AERIAL VIEW OF PROPERTIES AND EXTENT OF WORK NOTES 53 C:\03-023\PIPES AND ROADS 03-023 GPS.dwg 53S 22-Dec-08 3:54:20 PM

Interval 9 Cont.

900 to 1+250 902, 1+128 1+165

- Type VIIA canal work

- 2 irrigation lines - both 150mm, Type A2 work - Lateral ditch treatment


10

ORIGINAL SCALE

1:1000

Two (2) One (1)



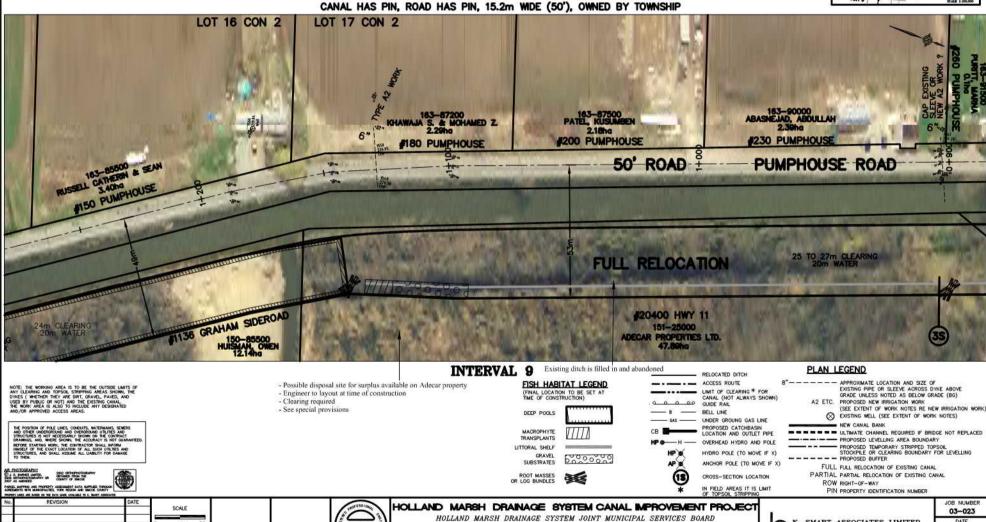

TOWN OF BRADFORD WEST GWILLIMBURY

AERIAL VIEW OF PROPERTIES AND EXTENT OF WORK NOTES

TOWNSHIP OF KING

COUNTY OF SIMCOE

ANUARY, 2009


DRAWING NUMBE

54

K. SMART ASSOCIATES LIMITED

CONSULTING ENGINEERS AND PLANNERS

85 McINTYRE DRIVE KITCHENER, ONTARIO

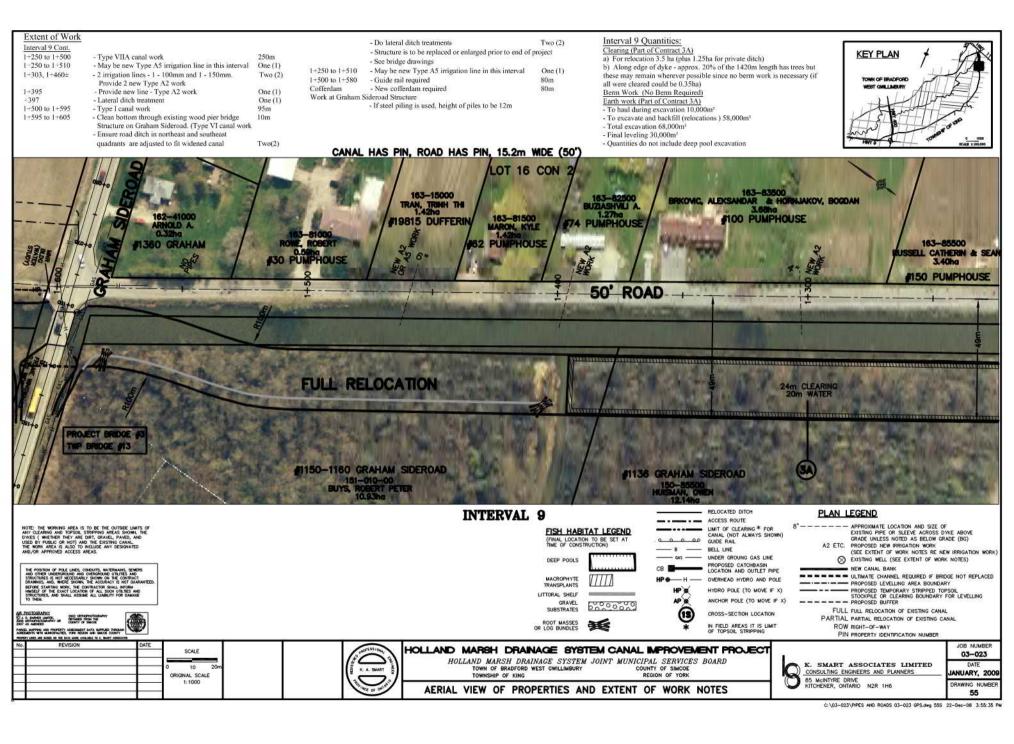

1-650±

Interval 10 (Part of Contract 1A)

1+605 to 1+950

- Type III-L canal work 1+705

- Lateral ditch treatment required 1+775

One (1) - Irrigation line 200mm - Add cap or capping plate, Type A3 work One (1)

- Construct new Type A5 work


- Confirm location with owner

One (1)

345m



CANAL HAS PIN, LANDS ON WEST SIDE OWN TO CANAL, WITH 15.2m (50') ROW FOR DYKE

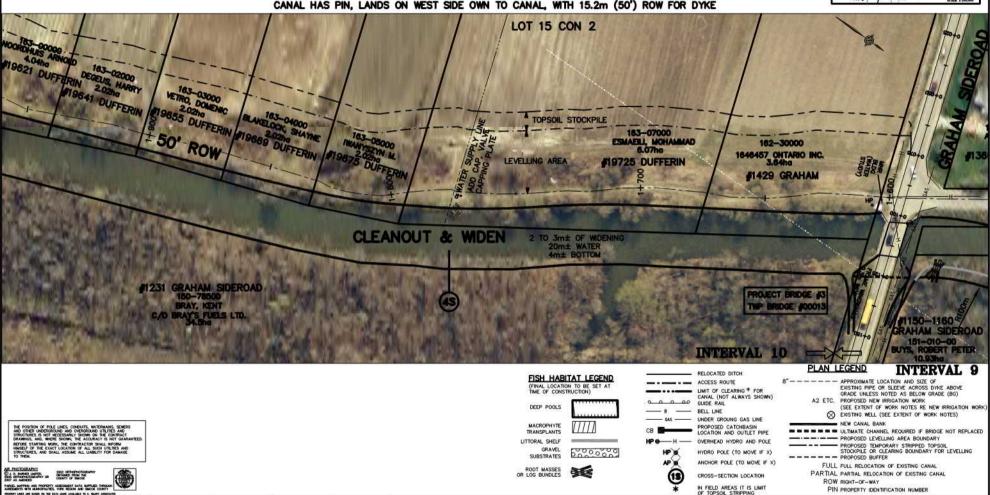

PARCE, MAPPING AND PROPERTY ASSESSMENT DATA SUPPLIED THROU ASSESSMENTS WITH MANOGRAPHES, YORK RECORD AND SHAPE OFFICE

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1.2	REVISION	DATE				
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HOLLAND MARSH DRAINAGE SYSTEM CANAL IMPROVEMENT PROJECT

HOLLAND MARSH DRAINAGE SYSTEM JOINT MUNICIPAL SERVICES BOARD TOWN OF BRADFORD WEST GWILLIMBURY COUNTY OF SIMCOE TOWNSHIP OF KING

AERIAL VIEW OF PROPERTIES AND EXTENT OF WORK NOTES

PIN PROPERTY IDENTIFICATION NUMBER

K. SMART ASSOCIATES LIMITED CONSULTING ENGINEERS AND PLANNERS 85 McINTYRE DRIVE KITCHENER, ONTARIO

JOB NUMBER 03-023 ANUARY, 2009 DRAWING NUMBE 56

Interval 10 Cont. 1-950 to 2+300

- Type III-L canal work 1+991 - Lateral ditch treatment 350m One (1) KEY PLAN

CANAL HAS PIN, LANDS ON WEST SIDE OWN TO CANAL, WITH 15.2m (50') ROW FOR DYKE



FISH HABITAT LEGEND (FINAL LOCATION TO BE SET AT TIME OF CONSTRUCTION)

DEEP POOLS MACROPHYTE TRANSPLANTS LITTORAL SHELF GRAVEL 000000 SUBSTRATES

ROOT MASSES OR LOG BUNDLES

--- ACCESS ROUTE LIMIT OF CLEARING * FOR CANAL (NOT ALWAYS SHOWN) GUIDE RAIL BELL LINE UNDER GROUNG GAS LINE PROPOSED CATCHBASIN LOCATION AND OUTLET PIPE

OVERHEAD HYDRO AND POLE HYDRO POLE (TO MOVE IF X) ANCHOR POLE (TO MOVE IF X) CROSS-SECTION LOCATION

8" — — — APPROXIMATE LOCATION AND SIZE OF EXISTING PIPE OR SLEEVE ACROSS DYKE ABOVE GRADE UNILESS NOTED AS BELOW GRADE (BG)

A2 ETC. PROPOSED NEW IRRIGATION WORK

(SEE EXTENT OF WORK NOTES RE NEW IRRIGATION WORK) EXISTING WELL (SEE EXTENT OF WORK NOTES) - NEW CANAL BANK

- - - - - ULTIMATE CHANNEL REQUIRED IF BRIDGE NOT REPLACED ----- PROPOSED LEVELLING AREA BOUNDARY PROPOSED TEMPORARY STRIPPED TOPSOIL STOCKPILE OR CLEARING BOUNDARY FOR LEVELLING ---- PROPOSED BUFFER

FULL FULL RELOCATION OF EXISTING CANAL PARTIAL PARTIAL RELOCATION OF EXISTING CANAL ROW RIGHT-OF-WAY

PIN PROPERTY IDENTIFICATION NUMBER

REVISION SCALE 10 ORIGINAL SCALE 1:1000

THE POSITION OF POLE LINES, CONDUITS, WATDIMANNS, SEMENS AND ORBET UNDERSTORMED AND ORDERSCHOOLD UTLIESE AND STRUCTURES IN ON HOCKESSAFELY FORMED IN THE CONTRACT ORBITALISM, WHERE SHOWN, THE ACCURACY IS NOT GUARANT BEFORE STANFANDE SHOWN, THE ACCURACY IS NOT GUARANT BEFORE STANFAND WORS, THE CONTRACTOR SHALL INFORM HIS DAY, OF THE SWAT LOCATION OF ALL SHOOT UT THE SWAT LOCATION OF ALL SHOOT OF COMMON.

PARCEL MAPPING AND PROPERTY ASSESSMENT SATA SUPPLIED THROUGH AGRESSMENTS WITH MARKSPALLTES, YORK RECOON AND SMICH COUNTY



IN FIELD AREAS IT IS LIMIT OF TOPSOIL STRIPPING HOLLAND MARSH DRAINAGE SYSTEM CANAL IMPROVEMENT PROJECT


HOLLAND MARSH DRAINAGE SYSTEM JOINT MUNICIPAL SERVICES BOARD TOWN OF BRADFORD WEST GWILLIMBURY COUNTY OF SIMCOE TOWNSHIP OF KING


AERIAL VIEW OF PROPERTIES AND EXTENT OF WORK NOTES



JOB NUMBER 03-023 ANUARY, 2009 DRAWING NUMBE 57

Extent of Work KEY PLAN Interval 10 Cont. 2+300 to 2+650 - Type III-Leanal work 350m 2+425 to 2+650 - 3m wide grass buffer required 225m 2+425, 2+610 - Lateral ditch treatments Two (2) 2+620 - Irrigation line - communal 350mm dia, (Type EC work) - Protect and do not disturb it One (1) CANAL HAS PIN, LANDS ON WEST SIDE OWN TO CANAL, CANAL OWNED BY LANDS ON EAST SIDE, LANDS ON WEST SIDE OWN TO CANAL 12.2m (40') DYKE ROW WITH 15.2m (50') ROW FOR DYKE LOT 13 CON 2 LOT 14 CON 2 RAÑOHAWA B., GILL J. & SEHMER, G. 11.33ha TOPSOIL STOCKPILE #19335 DUFFERIN ST 162-90500 162-87500 BALDEO, GAIL 162-85500 PONNAMPALAM, PAHMARAJAH LEVELLING AREA 162-82000 #19445 DUFFERIN ASKARYAR, NABILA 19411 DUFFERIN #19491 DUFFERIN 4.86ha #19431 DUFFERIN #19401 DUFFERIN 10' ROW 2 TO 3m± WIDENING 20m± WATER CLEANOUT & WIDEN 4m± BOTTOM \$1231 GRAHAM SIDEROAD #19420 BATHURST ST. 150-78500 150-38000 C/O BRAY'S FUELS LTD HUISMAN, GEORGE 36.42ha 3m wide buffer strip required **INTERVAL 10** PLAN LEGEND (typical where field abut canal) RELOCATED DITCH Minor widening as necessary (0 to 2m) to give -ACCESS ROUTE 8" --- - APPROXIMATE LOCATION AND SIZE OF EXISTING PIPE OR SLEEVE ACROSS DYKE ABOVE NOTE: THE WORKING AREA IS TO BE THE OUTSIDE LIMITS OF ANY CLEARING AND TOPSOL STRIPPING AREAS SHOWN, THE DYESS (WHETHER THEY ARE DIST, GRAVEL, PAVED, AND USED BY PUBLIC OR NOT) AND THE EYISTING CANAL, THE WORK AREA IS ALSO TO INCLUDE ANY DESIGNATED AND/OR APPROVED ACCESS NARLOS. FISH HABITAT LEGEND 20m± water when less than 20m exists at LIMIT OF CLEARING * FOR GRADE UNLESS NOTED AS BELOW GRADE (BG)
A2 ETC. PROPOSED NEW IRRIGATION WORK (FINAL LOCATION TO BE SET AT TIME OF CONSTRUCTION) elev. 218.75, 4m± bottom CANAL (NOT ALWAYS SHOWN) GUIDE RAIL (SEE EXTENT OF WORK NOTES RE NEW IRRIGATION WORK - BELL LINE EXISTING WELL (SEE EXTENT OF WORK NOTES) DEEP POOLS UNDER GROUNG GAS LINE - NEW CANAL BANK PROPOSED CATCHBASIN LOCATION AND OUTLET PIPE - - - - ULTIMATE CHANNEL REQUIRED IF BRIDGE NOT REPLACED MACROPHYTE TRANSPLANTS OVERHEAD HYDRO AND POLE PROPOSED TEMPORARY STRIPPED TOPSOIL STOCKPILE OR CLEARING BOUNDARY FOR LEVELLING LITTORAL SHELF HYDRO POLE (TO MOVE IF X) ---- PROPOSED BUFFER 000000 ANCHOR POLE (TO MOVE IF X) SUBSTRATES FULL FULL RELOCATION OF EXISTING CANAL PARTIAL PARTIAL RELOCATION OF EXISTING CANAL CROSS-SECTION LOCATION ROOT MASSES OR LOG BUNDLES 1 ROW RIGHT-OF-WAY IN FIELD AREAS IT IS LIMIT OF TOPSOIL STRIPPING PIN PROPERTY IDENTIFICATION NUMBER REVISION JOB NUMBER HOLLAND MARSH DRAINAGE SYSTEM CANAL IMPROVEMENT PROJECT SCALE 03-023 HOLLAND MARSH DRAINAGE SYSTEM JOINT MUNICIPAL SERVICES BOARD K. SMART ASSOCIATES LIMITED TOWN OF BRADFORD WEST GWILLIMBURY COUNTY OF SIMCOE CONSULTING ENGINEERS AND PLANNERS ANUARY, 2009 ORIGINAL SCALE TOWNSHIP OF KING 1:1000 DRAWING NUMBE AERIAL VIEW OF PROPERTIES AND EXTENT OF WORK NOTES 58 C: \03-023\PIPES AND ROADS 03-023 GPS.dwg 58S 22-Dec-08 3:57:00 PM

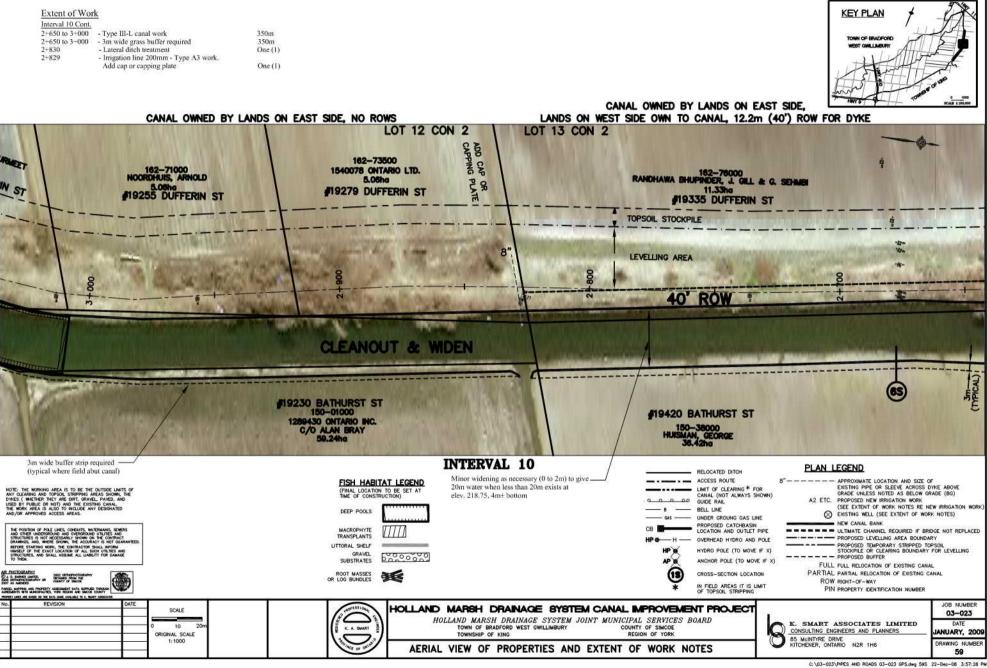


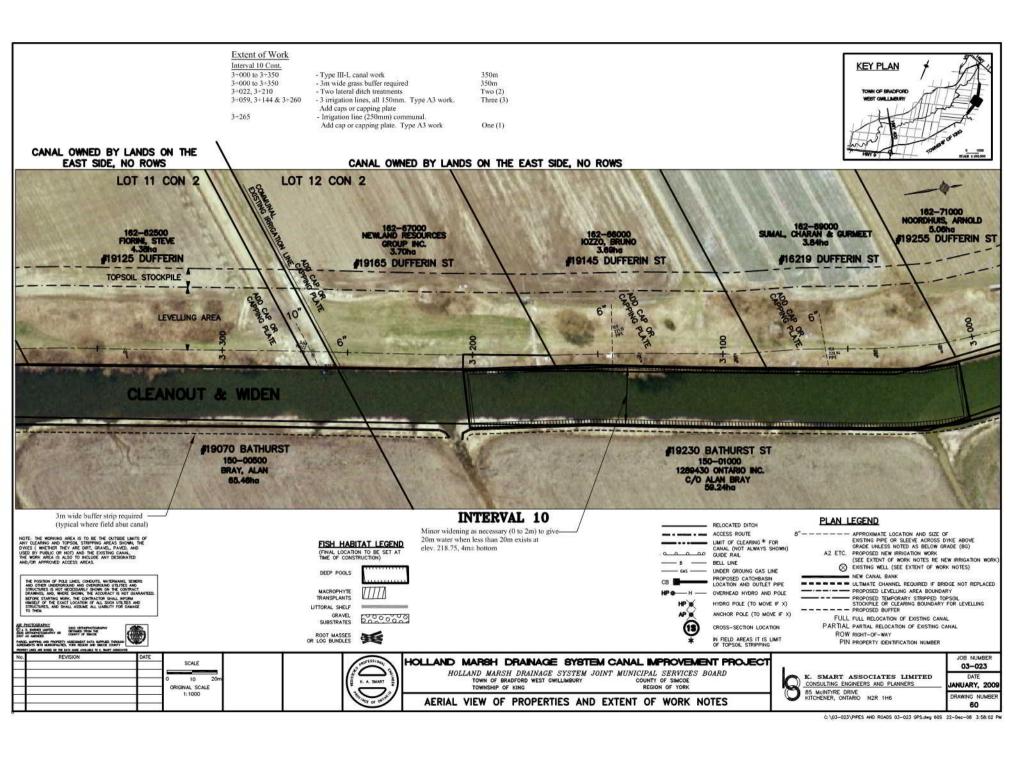



Extent of Work KEY PLAN Interval 10 Cont. 3+350 to 3+700 - Type III-L canal work 350m 3+350 to 3+700 - 3m wide grass buffer required 350m 3+396 & 3-700 - 2 lateral ditch treatments Two (2) 3+600 to 3+70 0 - Dyke needs repair in this interval 100m CANAL OWNED BY LANDS ON THE EAST SIDE, NO ROWS LOT 11 CON 2 CORNACCHIA, ROCCO & MARIA #19125 DUFFERIN #19101 DUFFERIN #19075 DUFFERIN TOPSOIL STOCKP TOPSOIL STOCKPILE 162-56000 PHILIPP, RICHARD ANG, YO NA LEVELLING AREA 9035 DUFFERIN 19025 DUFFERIN CLEANOUT & WIDEN #19070 BATHURST INTERVAL 10 3m wide buffer strip required PLAN LEGEND RELOCATED DITCH (typical where field abut canal) Minor widening as necessary (0 to 2m) to give . - ACCESS ROUTE APPROXIMATE LOCATION AND SIZE OF EXISTING PIPE OR SLEEVE ACROSS DYNE ABOVE GRADE UNILESS NOTED AS BELOW GRADE (BG)
A2 ETC. PROPOSED NEW IRRIGATION WORK NOTE: THE WORKING AREA IS TO BE THE CUTSIDE LIMITS OF ANY CLEARING AND TOPSOR, STRIPPING AREAS SHOWN. THE DIVISES (WHETHER THEY ARE DIRT, GRAVEL, PAVED, AND USED BY PUBLIC OR NOT) AND THE EXISTING CANAL. THE WORK AREA IS ALSO TO INCLUDE ANY DESIGNATED AND/OR APPROVED ACCESS AREAS. FISH HABITAT LEGEND 20m water when less than 20m exists at LIMIT OF CLEARING * FOR elev. 218.75, 4m± bottom CANAL (NOT ALWAYS SHOWN) O.O GUIDE RAIL - BELL LINE (SEE EXTENT OF WORK NOTES RE NEW IRRIGATION WORK) DEEP POOLS EXISTING WELL (SEE EXTENT OF WORK NOTES) UNDER GROUNG GAS LINE PROPOSED CATCHBASIN LOCATION AND OUTLET PIPE - NEW CANAL BANK MACROPHYTE - - - - ULTIMATE CHANNEL REQUIRED IF BRIDGE NOT REPLACED - OVERHEAD HYDRO AND POLE TRANSPI ANTS ----- PROPOSED LEVELLING AREA BOUNDARY PROPOSED TEMPORARY STRIPPED TOPSOIL STOCKPILE OR CLEARING BOUNDARY FOR LEVELLING LITTORAL SHELF HYDRO POLE (TO MOVE IF X) GRAVEL 000000 ---- PROPOSED BUFFER ANCHOR POLE (TO MOVE IF X) SUBSTRATES FULL FULL RELOCATION OF EXISTING CANAL (13) CROSS-SECTION LOCATION PARTIAL PARTIAL RELOCATION OF EXISTING CANAL OR LOG BUNDLES ROW RIGHT-OF-WAY IN FIELD AREAS IT IS LIMIT OF TOPSOIL STRIPPING PARCEL MAPPING AND PROPERTY ASSESSMENT SATA SUPPLIED THROUGH AGRESSMENTS WITH MARKSPALLTES, YORK RECOON AND SMICH COUNTY PIN PROPERTY IDENTIFICATION NUMBER K. SMART ASSOCIATES LIMITED CONSULTING ENGINEERS AND PLANNERS S. McINTYRE DRAW! REVISION JOB NUMBER HOLLAND MARSH DRAINAGE SYSTEM CANAL IMPROVEMENT PROJECT SCALE 03-023 HOLLAND MARSH DRAINAGE SYSTEM JOINT MUNICIPAL SERVICES BOARD 10 TOWN OF BRADFORD WEST GWILLIMBURY COUNTY OF SIMCOE ANUARY, 2009 ORIGINAL SCALE TOWNSHIP OF KING 1:1000 DRAWING NUMBE


AERIAL VIEW OF PROPERTIES AND EXTENT OF WORK NOTES

61

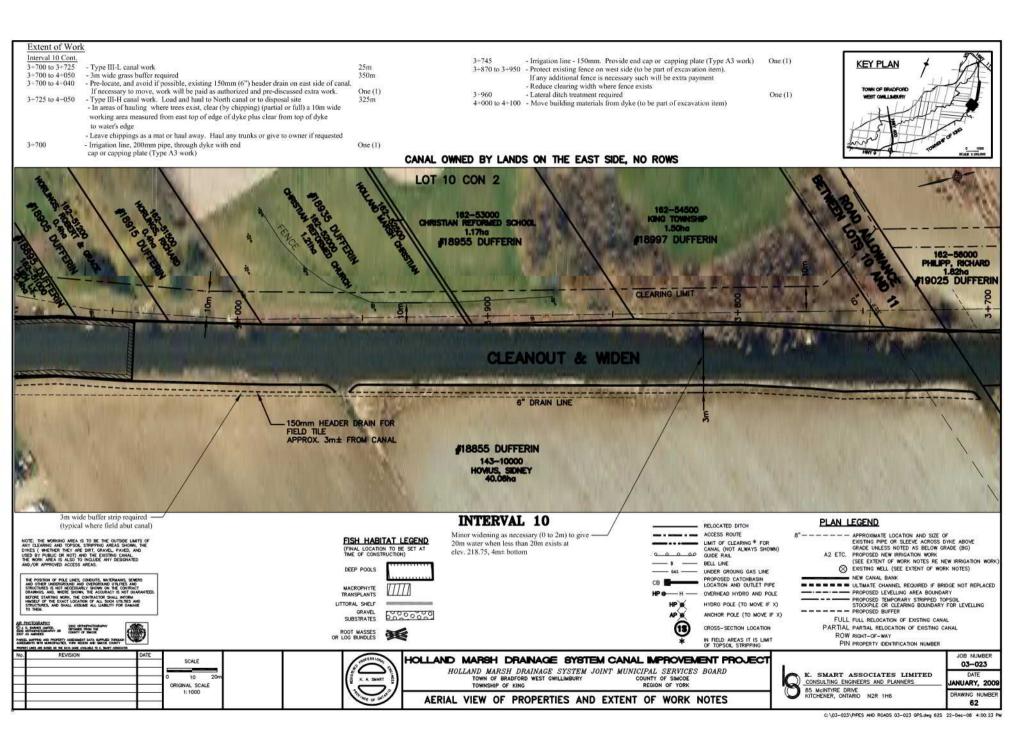

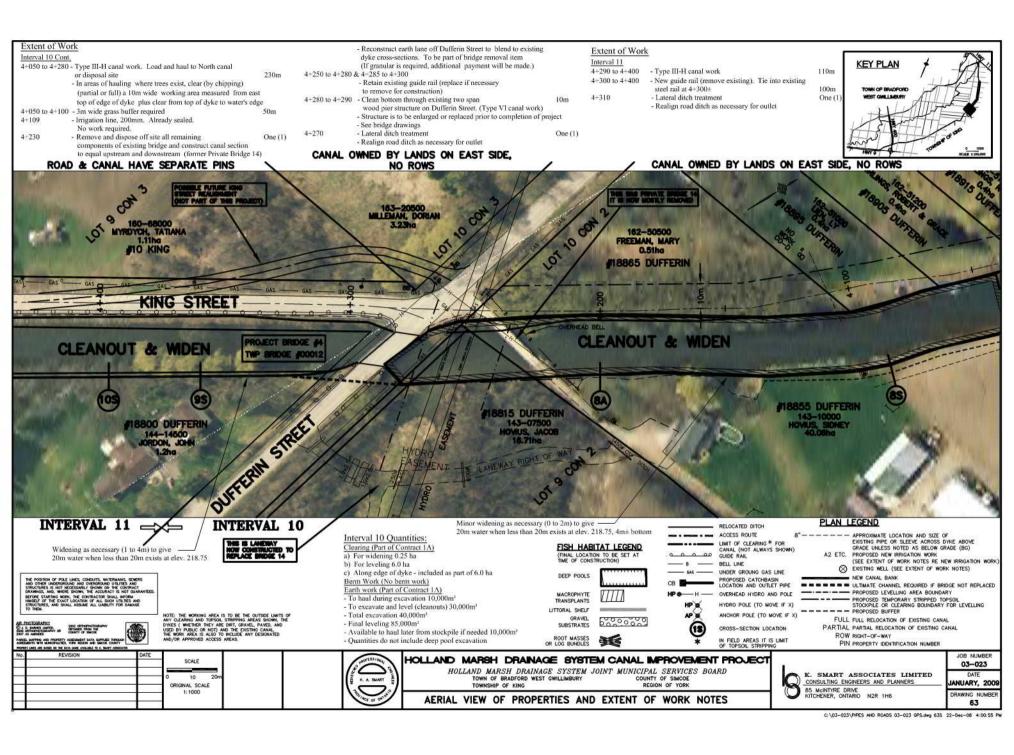

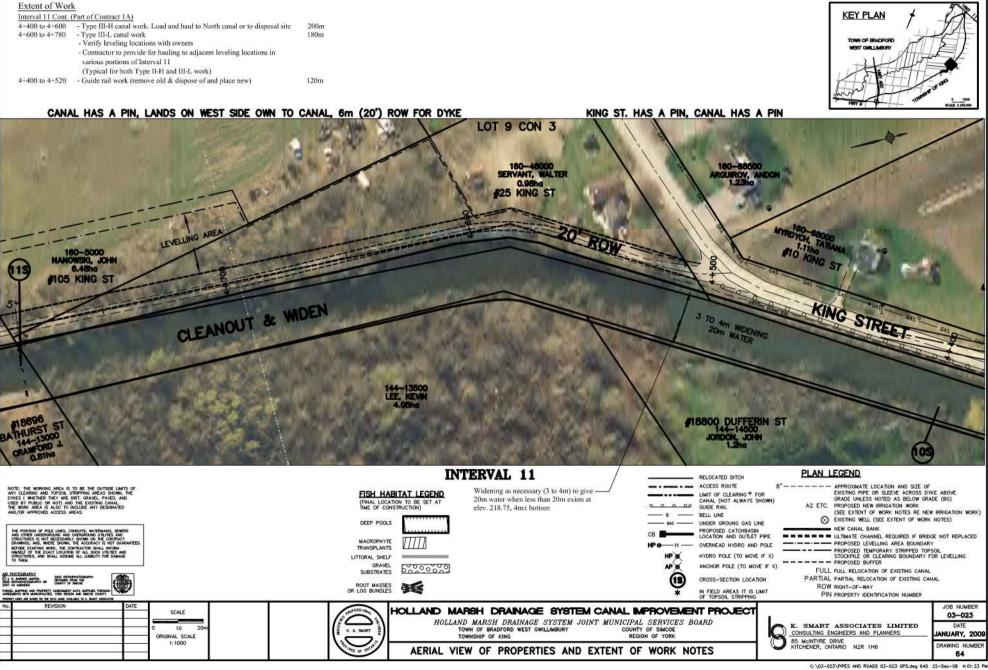

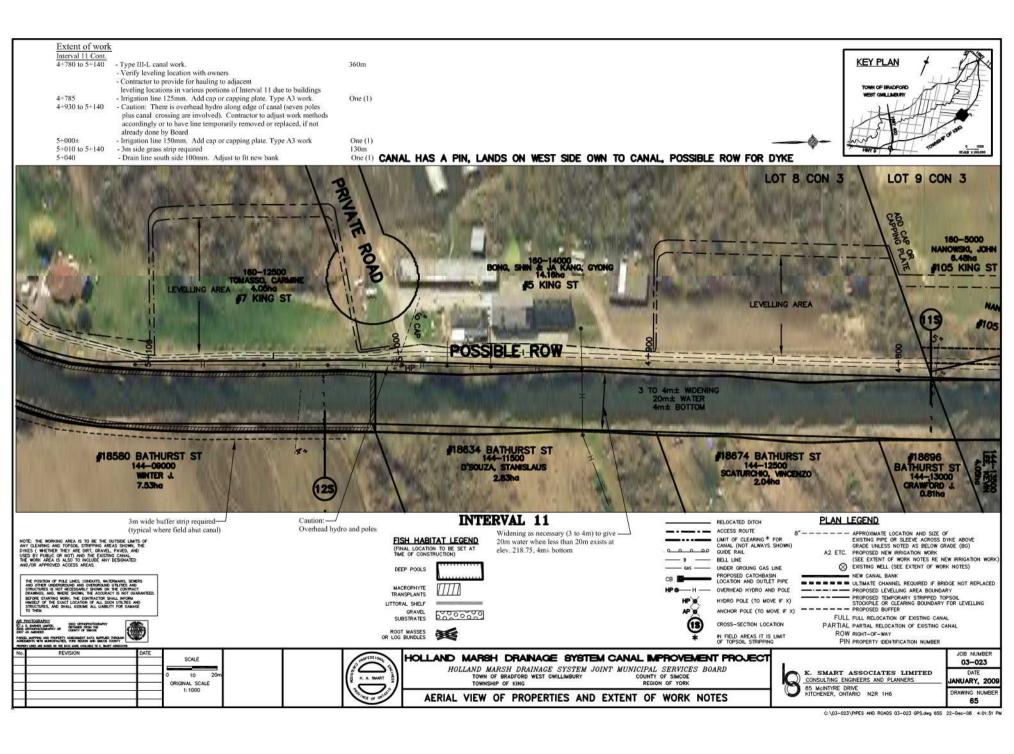

Extent of Work Interval 11 Cont. KEY PLAN 5+140 to 5+500 - Type III-L canal work. 360m - Verify leveling location with owners - Contractor to provide for hauling to adjacent leveling locations in various portions of Interval 11 due to buildings - Dyke needs repair in this interval 360m 5+140 to 5+585 - There is a well outlet on J. Winter property (outside of marsh) in this interval, to be extended. Type G-E work One(1) CANAL HAS A PIN, LANDS ON WEST SIDE OWN TO CANAL, POSSIBLE ROW FOR DYKE LOT 8 CON 3 TOPSOIL STOCKPILE AREA 160-12500 TOMASSO CARMINE LEVELLING AREA LEVELLING AREA #7 KING ST TO 4m WIDENING 8 LOT LINE OUFFERIN ST Widening as necessary (3 to 4m) to give -PLAN LEGEND INTERVAL 11 RELOCATED DITCH 20m water when less than 20m exists at elev. 218.75, 4m± bottom - ACCESS ROUTE APPROXIMATE LOCATION AND SIZE OF EXISTING PIPE OR SLEEVE ACROSS DYNE ABOVE GRADE UNLESS NOTED AS BELOW GRADE (BG) A2 ETC. PROPOSED NEW IRRIGATION WORK NOTE: THE WORKING AREA IS TO BE THE OUTSDE LIMITS OF ANY CLEARING AND TOPOUL STRIPPING AREA SHOWN, THE OYUGE ("METHER THEY ARE ORT, GRAVE). PAYOD, AND USED BY PUBLIC OR NOT) AND THE DISTING CAMAL THE WORK AREA IS ALSO TO INCLUDE ANY DESIGNATED AND/OR APPROVED ACCESS AREAS. LIMIT OF CLEARING * FOR FISH HABITAT LEGEND CANAL (NOT ALWAYS SHOWN) GUIDE RAIL (FINAL LOCATION TO BE SET AT TIME OF CONSTRUCTION) (SEE EXTENT OF WORK NOTES RE NEW IRRIGATION WORK) EXISTING WELL (SEE EXTENT OF WORK NOTES) - BELL LINE - UNDER GROUNG GAS LINE DEEP POOLS NEW CANAL BANK PROPOSED CATCHBASIN LOCATION AND OUTLET PIPE - - - - ULTIMATE CHANNEL REQUIRED IF BRIDGE NOT REPLACED OVERHEAD HYDRO AND POLE ---- PROPOSED LEVELLING AREA BOUNDARY MACROPHYTE PROPOSED TEMPORARY STRIPPED TOPSOIL STOCKPILE OR CLEARING BOUNDARY FOR LEVELLING TRANSPLANTS HYDRO POLE (TO MOVE IF X) LITTORAL SHELF --- PROPOSED BUFFER ANCHOR POLE (TO MOVE IF X) GRAVEL 6000000 FULL FULL RELOCATION OF EXISTING CANAL (13) CROSS-SECTION LOCATION PARTIAL PARTIAL RELOCATION OF EXISTING CANAL ROW RIGHT-OF-WAY ROOT MASSES OR LOG BUNDLES IN FIELD AREAS IT IS LIMIT OF TOPSOIL STRIPPING PIN PROPERTY IDENTIFICATION NUMBER REVISION JOB NUMBER HOLLAND MARSH DRAINAGE SYSTEM CANAL IMPROVEMENT PROJECT SCALE 03-023 HOLLAND MARSH DRAINAGE SYSTEM JOINT MUNICIPAL SERVICES BOARD K. SMART ASSOCIATES LIMITED TOWN OF BRADFORD WEST GWILLIMBURY TOWNSHIP OF KING COUNTY OF SIMCOE CONSULTING ENGINEERS AND PLANNERS ANUARY, 2009 ORIGINAL SCALE 85 McINTYRE DRIVE KITCHENER, ONTARIO 1:1000 DRAWING NUMBE AERIAL VIEW OF PROPERTIES AND EXTENT OF WORK NOTES

Interval 11 Quantities: Extent of Work Clearing (Part of Contract 1A) KEY PLAN a) For widening 0.45 ha Interval 11 Cont. b) For leveling 3.7 ha 5+500 to 5-870 - Type III-L canal work. b) Along edge of dyke - included as part of 3.7 ha - Verify leveling location with owners Berm Work (No Berm Required) - Contractor to provide for hauling to adjacent Earth work (Part of Contract 1A) leveling locations in various portions of Interval 11 due to buildings To haul during excavation 6.500m³ 5+750 to 5+870 - Protect existing fence during and as part of excavation work To excavate and level (cleanouts) 30,000m³. 8,000m³ to move/haul laterally at building site. - Total excavation 36,500m3 - Final leveling 53,000m² Available to haul later from stockpiles if needed 6,500m³ - Quantities do not include deep pool excavation CANAL HAS A PIN, LANDS ON WEST SIDE OWN TO CANAL, POSSIBLE ROW FOR DYKE LOT 7 CON 3 LOT 8 CON WNDROW TOPSOIL STOCKPILE 50-05000 OUR, STEPHEN 11.48ha \$545 LIPCHEY RD LEVELLING AREA 18495 KEELE ST (MAY BE MOVED) POSSIBLE ROW CLEANOUT & WIDEN 18495 DUFFERIN S Widening as necessary (3 to 4m) to give -PLAN LEGEND INTERVAL 12 INTERVAL 11 RELOCATED DITCH 20m water when less than 20m exists at elev. 218.75, 4m± bottom ACCESS ROUTE APPROXIMATE LOCATION AND SIZE OF EXISTING PIPE OR SLEEVE ACROSS DYNE ABOVE GRADE UNLESS NOTED AS BELOW GRADE (BG)
A2 ETC. PROPOSED NEW IRRIGATION WORK LIMIT OF CLEARING * FOR FISH HABITAT LEGEND CANAL (NOT ALWAYS SHOWN) OD GUIDE RAIL (FINAL LOCATION TO BE SET AT (SEE EXTENT OF WORK NOTES RE NEW IRRIGATION WORK)

EXISTING WELL (SEE EXTENT OF WORK NOTES) BELL LINE UNDER GROUNG GAS LINE PROPOSED CATCHBASIN LOCATION AND OUTLET PIPE NEW CANAL BANK NOTE: THE WORKING AREA IS TO BE THE OUTSIDE LIMITS OF ANY CLEARING AND TOPSOL STRIPPING AREAS SHOWN, THE DYKES (WHETHER THEY ARE DRIT, GRAVEL, PAVED, AND USED BY PUBLIC OR NOT) AND THE DISTING CAMA. THE WORK AREA IS ALSO TO INCLUDE ANY DESIGNATED MANY/DR APPORTURE ASSOCIATION OF THE AREA OF TH - - - - - ULTIMATE CHANNEL REQUIRED IF BRIDGE NOT REPLACED ---- PROPOSED LEVELLING AREA BOUNDARY OVERHEAD HYDRO AND POLE MACROPHYTE PROPOSED TEMPORARY STRIPPED TOPSOIL STOCKPILE OR CLEARING BOUNDARY FOR LEVELLING TRANSPLANTS HYDRO POLE (TO MOVE IF X) LITTORAL SHELF --- PROPOSED BUFFER ANCHOR POLE (TO MOVE IF X) GRAVEL 500000 FULL FULL RELOCATION OF EXISTING CANAL (13) SUBSTRATES CROSS-SECTION LOCATION PARTIAL PARTIAL RELOCATION OF EXISTING CANAL ROW RIGHT-OF-WAY IN FIELD AREAS IT IS LIMIT OF TOPSOIL STRIPPING PIN PROPERTY IDENTIFICATION NUMBER REVISION

SCALE

ORIGINAL SCALE

1:1000

HOLLAND MARSH DRAINAGE SYSTEM CANAL IMPROVEMENT PROJECT

HOLLAND MARSH DRAINAGE SYSTEM JOINT MUNICIPAL SERVICES BOARD

AERIAL VIEW OF PROPERTIES AND EXTENT OF WORK NOTES

COUNTY OF SIMCOE

TOWN OF BRADFORD WEST GWILLIMBURY

TOWNSHIP OF KING

K. SMART ASSOCIATES LIMITED


CONSULTING ENGINEERS AND PLANNERS

JOB NUMBER

03-023

ANUARY, 2009

DRAWING NUMBE

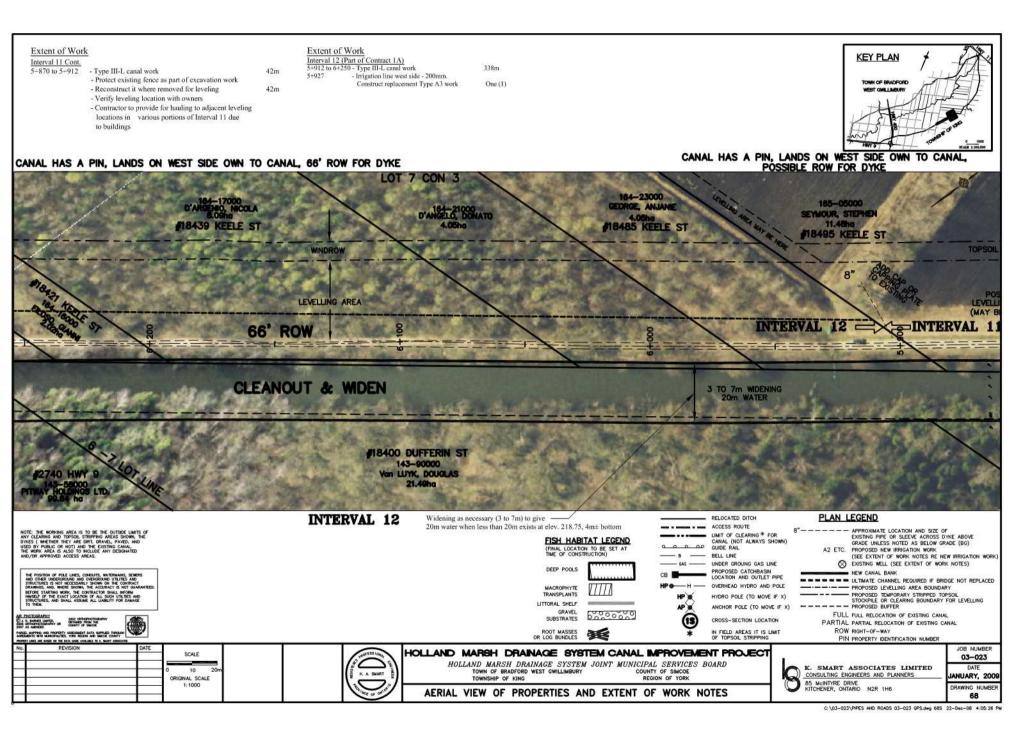

Extent of Work Interval 12 Cont.

6+250 to 6+600 - Type III-L canal work

350m







Extent of Work Interval 12 Cont.


6+600 to 6+970 - Type III-L canal work

370m



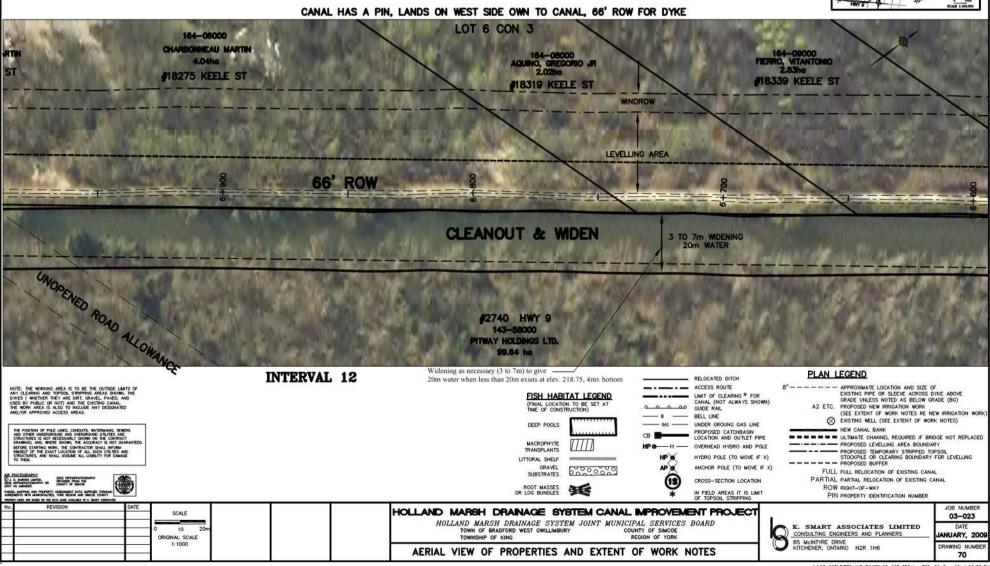

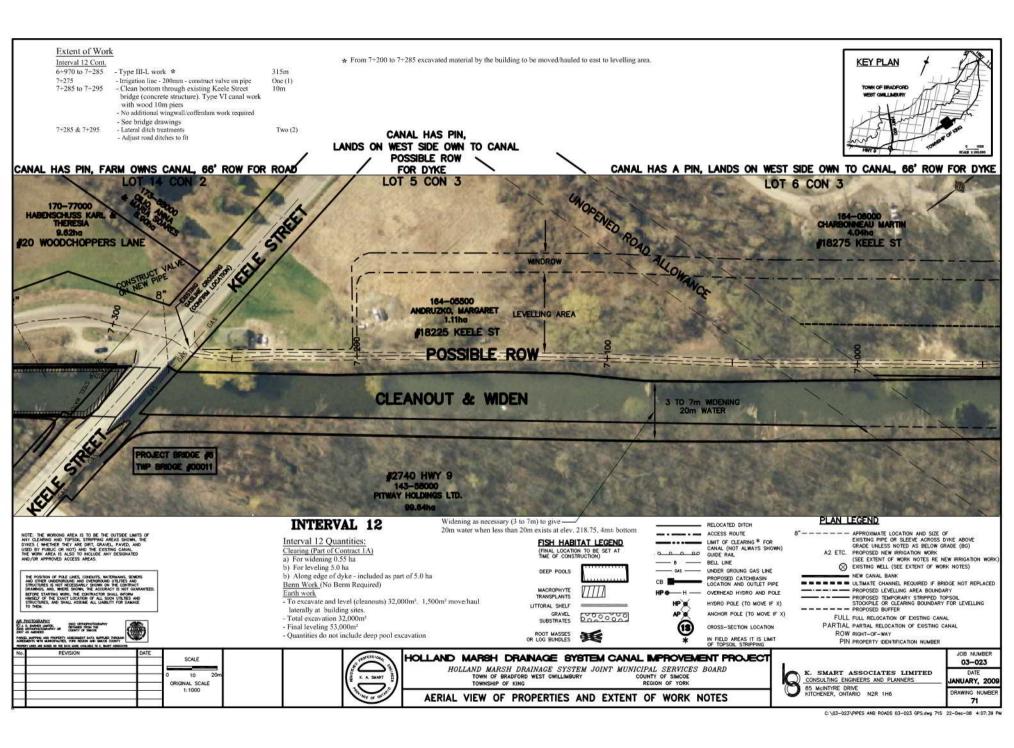

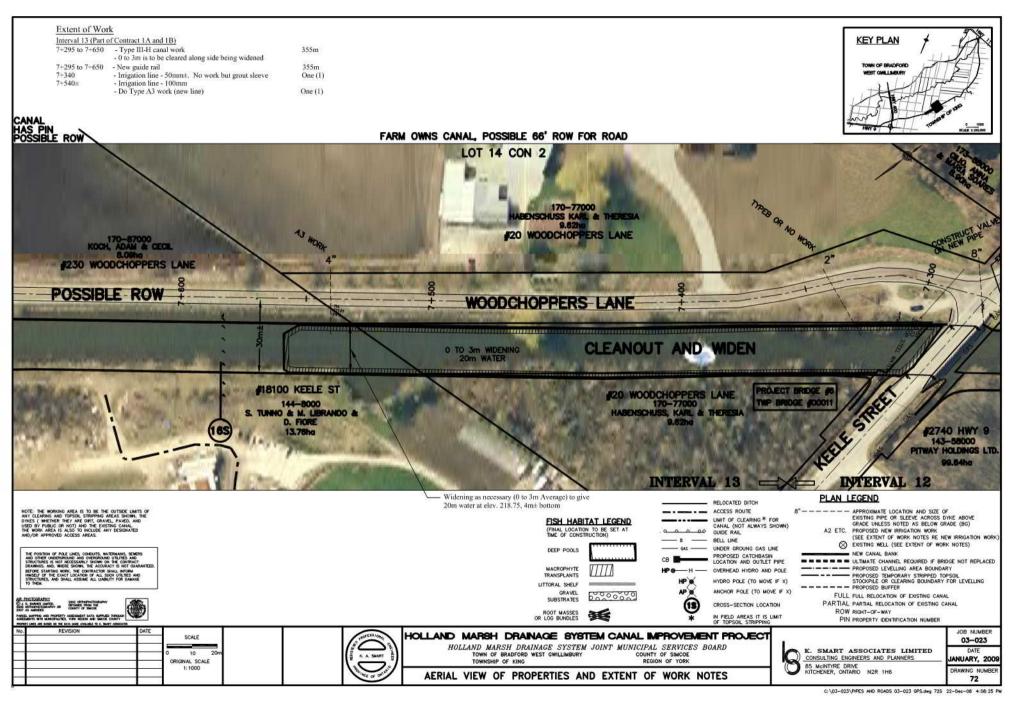

Extent of Work

Interval 13 Cont. *

7+650 to 7+675 - Type III-H canal work (0 to 3m clearing requied

25m for widening) 7+650 to 7+750 - New guide mil 100m


7+675 to 7-750 - Type I canal work 75m 7+675 to 7+750 - New cofferdam required 75m

- Provide for 12m long piles if steel 7+750 to 8+000 - Type VIIA canal work 250m

- Irrigation line - 100m - Type A3 work (new line) 7+675 One (1) * In Interval 13, all clearing has been done from Sta. 7+670 upstream along route for new canal where it is to be relocated

Clearing still necessary in cleanout and widening areas and is still required along existing dyke.



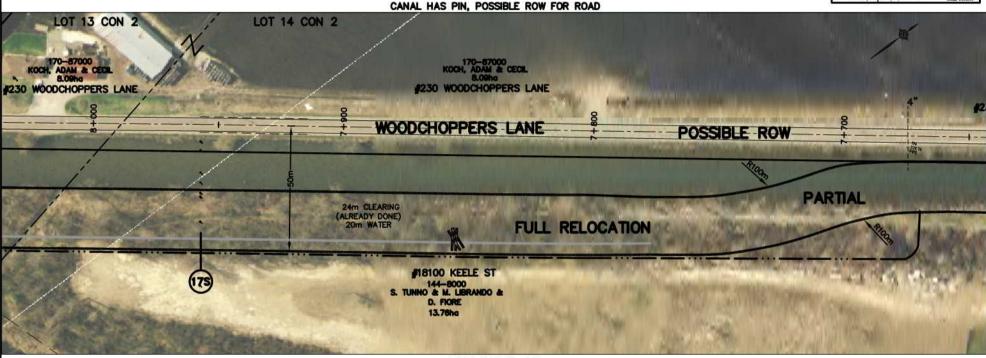

INTERVAL 13

NOTE: THE WORKING AREA IS TO BE THE CUTSIDE LIMITS OF ANY CLEARING AND TOPSOIL STREPPING AREAS SHOWN, THE DIKES (WHETHER THEY ARE DRIT, GRAVEL PAVED, AND USED BY PUBLIC OR NOT) AND THE EXISTING CANAL. THE WORK AREA IS ALSO TO INCLUDE ANY DESIGNATED



1:1000



FISH HABITAT LEGEND

(FINAL LOCATION TO BE SET AT

DEEP POOLS MACROPHYTE TRANSPLANTS LITTORAL SHELF GRAVEL

500000 SUBSTRATES

RELOCATED DITCH - ACCESS BOUTE LIMIT OF CLEARING * FOR CANAL (NOT ALWAYS SHOWN) Q GUIDE RAIL - BELL LINE UNDER GROUNG GAS LINE PROPOSED CATCHRASIN

HP W

AP S

13

OVERHEAD HYDRO AND POLE HYDRO POLE (TO MOVE IF X) ANCHOR POLE (TO MOVE IF X) CROSS-SECTION LOCATION

IN FIELD AREAS IT IS LIMIT OF TOPSOIL STRIPPING

PLAN LEGEND

APPROXIMATE LOCATION AND SIZE OF EXISTING PIPE OR SLEEVE ACROSS DYKE ABOVE GRADE UNILESS NOTED AS BELOW GRADE (BG)
A2 ETC. PROPOSED NEW IRRIGATION WORK

(SEE EXTENT OF WORK NOTES RE NEW IRRIGATION WORK EXISTING WELL (SEE EXTENT OF WORK NOTES) NEW CANAL BANK


- - - - - ULTIMATE CHANNEL REQUIRED IF BRIDGE NOT REPLACED ----- PROPOSED LEVELLING AREA BOUNDARY PROPOSED TEMPORARY STRIPPED TOPSOIL STOCKPILE OR CLEARING BOUNDARY FOR LEVELLING --- PROPOSED BUFFER

FULL FULL RELOCATION OF EXISTING CANAL PARTIAL PARTIAL RELOCATION OF EXISTING CANAL ROW RIGHT-OF-WAY PIN PROPERTY IDENTIFICATION NUMBER

HOLLAND MARSH DRAINAGE SYSTEM CANAL IMPROVEMENT PROJECT HOLLAND MARSH DRAINAGE SYSTEM JOINT MUNICIPAL SERVICES BOARD TOWN OF BRADFORD WEST GWILLIMBURY COUNTY OF SIMCOE

TOWNSHIP OF KING AERIAL VIEW OF PROPERTIES AND EXTENT OF WORK NOTES K. SMART ASSOCIATES LIMITED CONSULTING ENGINEERS AND PLANNERS 85 McINTYRE DRIVE KITCHENER, ONTARIO

JOB NUMBER 03-023 ANUARY, 2009 DRAWING NUMBE 73

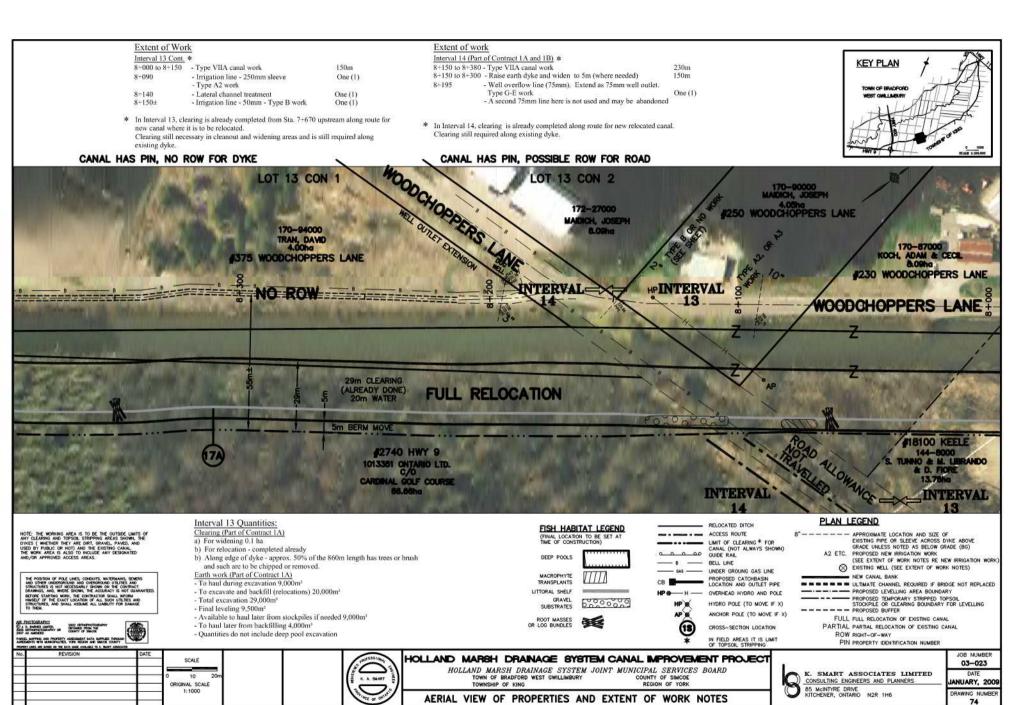


Extent of Work Interval 14 Cont. * KEY PLAN 8+200 to 8+580 - Provide new irrigation line if required (Type A6 work) One (1) 8+380 to 8+750 - Type VIIA canal work 370m * In Interval 14, clearing is already done along route for new relocated canal. 8+450 to 8+750 - Raise earth dyke and widen to 5m (where needed) 300m Clearing still required along existing dyke edge. 8+595 to 8+750 - A 24m easement from edge of water to south exists and new canal is to be in this easement - Berm to be moved to south of new canal in 5m width 8+580 to 8+780 - Provide new irrigation line if required (Type A6 work) One (1) CANAL HAS PIN, NO ROW FOR DYKE, 80' EASEMENT TO SOUTH OF CANAL CANAL HAS PIN, NO ROW FOR DYKE LOT 12 CON 1 LOT 13 CON 1 170-94000 TRAN, DAVID NO ROW 4.00ha #375 WOODCHOPPERS LANE 80' EASEMENT **FULL RELOCATION** #2740 HWY 9 140-74500 542215 ONTARIO LTD. #2740 HWY 9 144-70000 CARDINAL GOLF COURSE 137.5ha 1013351 ONTARIO LTD. CARDINAL GOLF COURSE **INTERVAL 14** PLAN LEGEND - In Lot 11 and 12 Con 1 RELOCATED DITCH Engineer will flag the 24m easment NOTE: THE WORKING AREA IS TO BE THE OUTSIDE LIMITS OF ANY CLEARING AND TOPSOR STRIPPING AREAS SHOWN, THE DIVISES (WHETER THEY ARE DRIT, GRAVE), PAVED, AND USED BY PUBLIC OR NOT) AND THE DISTING CANAL. THE WORK AREA IS ALSO TO INCLUDE ANY DESIGNATED AND/OR APPROVED ACCESS AREAS. - ACCESS ROUTE 8"---- APPROXIMATE LOCATION AND SIZE OF
EXISTING PIPE OR SLEEVE ACROSS DYKE ABOVE
GRADE UNLESS NOTED AS BELOW GRADE (BG) FISH HABITAT LEGEND LIMIT OF CLEARING * FOR (FINAL LOCATION TO BE SET AT CANAL (NOT ALWAYS SHOWN A2 ETC. PROPOSED NEW IRRIGATION WORK GUIDE RAIL (SEE EXTENT OF WORK NOTES RE NEW IRRIGATION WORK)


EXISTING WELL (SEE EXTENT OF WORK NOTES) BELL LINE DEEP POOLS UNDER GROUNG GAS LINE NEW CANAL BANK PROPOSED CATCHBASIN LOCATION AND OUTLET PIPE - - - - - ULTIMATE CHANNEL REQUIRED IF BRIDGE NOT REPLACED MACROPHYTE TRANSPLANTS ----- PROPOSED LEVELLING AREA BOUNDARY OVERHEAD HYDRO AND POLE PROPOSED TEMPORARY STRIPPED TOPSOIL STOCKPILE OR CLEARING BOUNDARY FOR LEVELLING LITTORAL SHELF HYDRO POLE (TO MOVE IF X) GRAVEL 5000000 ---- PROPOSED BUFFER ANCHOR POLE (TO MOVE IF X) SUBSTRATES AP W FULL FULL RELOCATION OF EXISTING CANAL (13) PARTIAL PARTIAL RELOCATION OF EXISTING CANAL CROSS-SECTION LOCATION ROW RIGHT-OF-WAY IN FIELD AREAS IT IS LIMIT PIN PROPERTY IDENTIFICATION NUMBER REVISION JOB NUMBER HOLLAND MARSH DRAINAGE SYSTEM CANAL IMPROVEMENT PROJECT SCALE 03-023 HOLLAND MARSH DRAINAGE SYSTEM JOINT MUNICIPAL SERVICES BOARD K. SMART ASSOCIATES LIMITED 10 TOWN OF BRADFORD WEST GWILLIMBURY COUNTY OF SIMCOE CONSULTING ENGINEERS AND PLANNERS ANUARY, 2009 ORIGINAL SCALE TOWNSHIP OF KING 1:1000


AERIAL VIEW OF PROPERTIES AND EXTENT OF WORK NOTES


DRAWING NUMBE

75

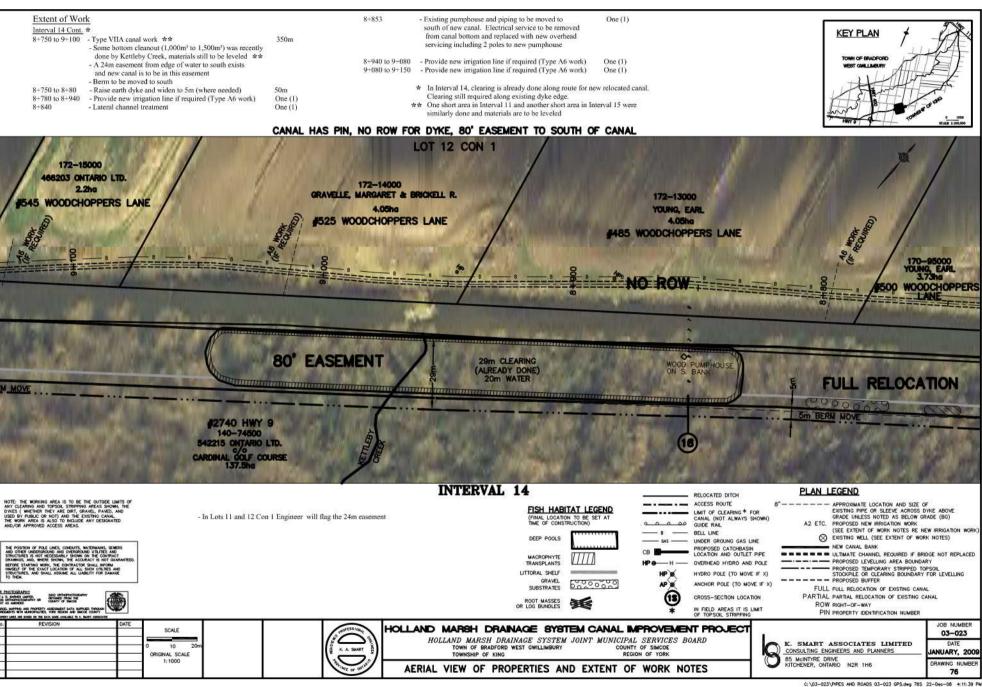

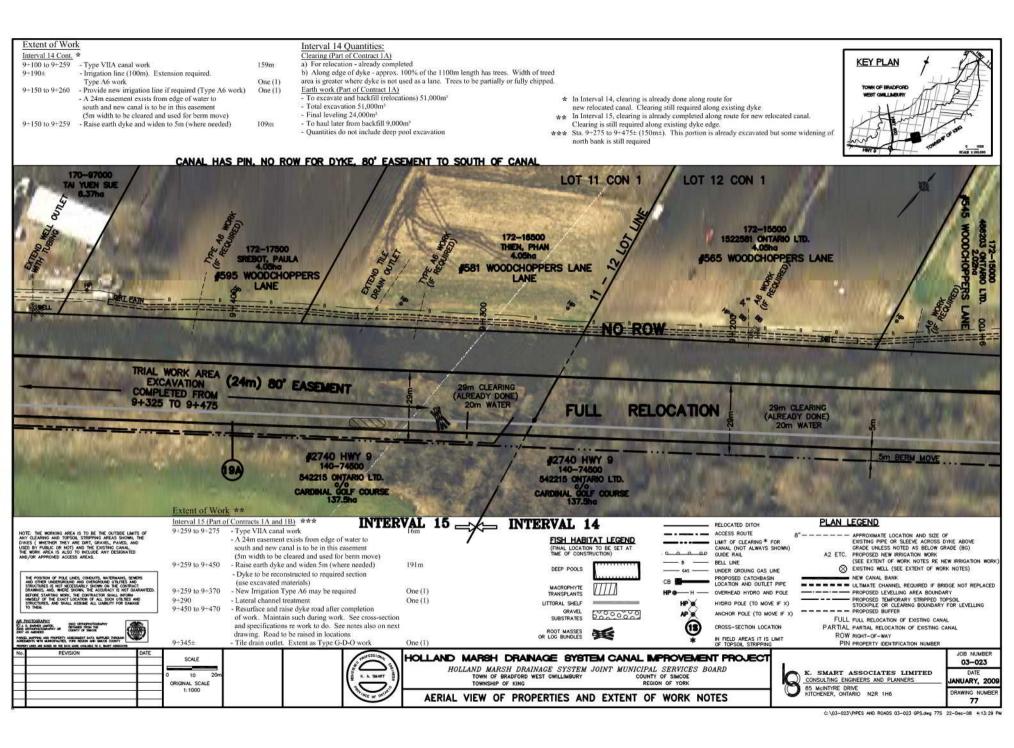

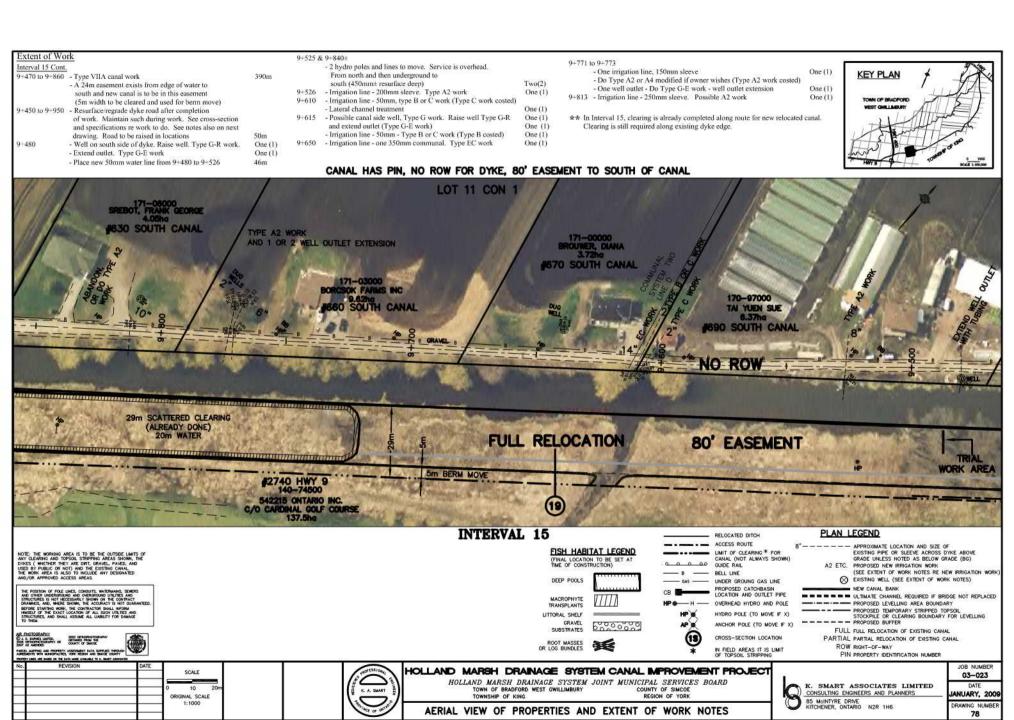

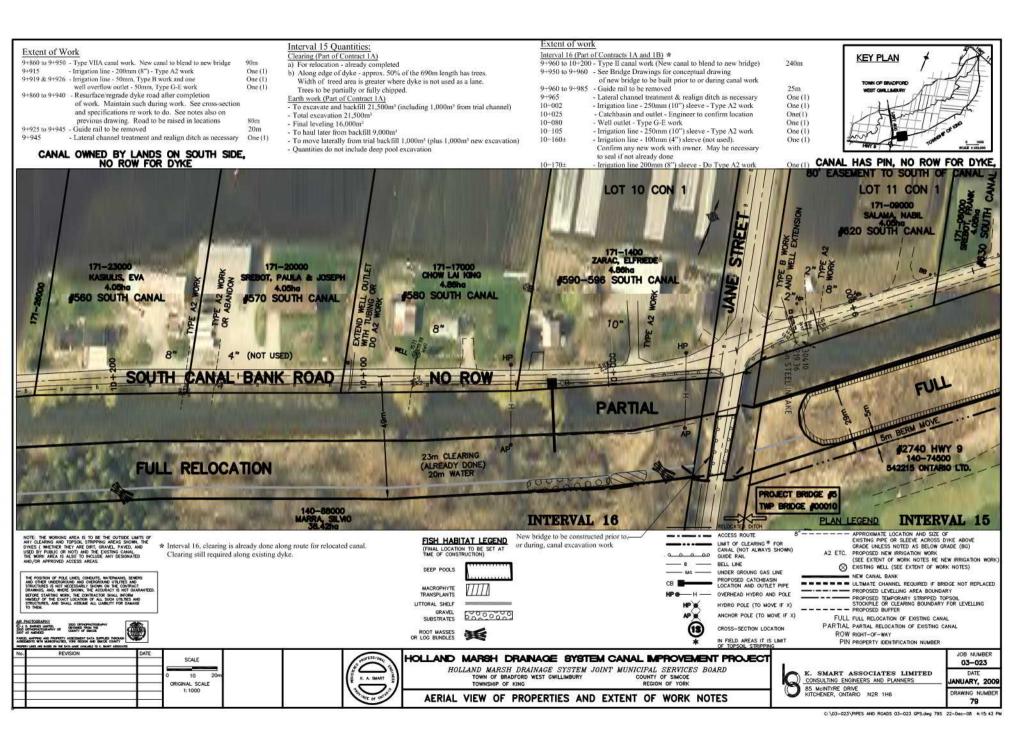

Extent of Work Interval 16 Cont. *

10+550±

350m 10+200 to 10+550 - Type II canal work (full relocation with berm) 10+310 - Irrigation line - 350mm communal - Type EC work One (1) 10+350 - Irrigation line - 200mm (8") sleeve - Type A2 work One (1) 10+420 - Irrigation line - 150mm(6") - Type A2, A4 or E work One (1) Engineer to advise. Type E work is costed 10+533 - Irrigation line - 150mm (6") pipe - Type A2, A4 Modified or E One (1) work. Engineer to advise. Type E work is costed

- Catchbasin and outlet. Engineer to confirm location

* Interval 16, clearing is already done along route for relocated canal. Clearing still required along existing dyke.



CANAL OWNED BY LANDS ON SOUTH SIDE, NO ROW FOR DYKE



PARCEL MAPPHO AND PROPERTY ASSESSMENT DATA SUPPLIED THROUGH AGRETACHTS WITH MANOGRAPHES, YORK REGION AND SMICE COUNTY



lo.	REVISION	DATE	SCALE
1			0 10 20m
1			ORIGINAL SCALE 1:1000
+		_	- 1



One (1)

INTERVAL 16

TOWN OF BRADFORD WEST GWILLIMBURY

FISH HABITAT LEGEND (FINAL LOCATION TO BE SET AT

DEEP POOLS MACROPHYTE TRANSPLANTS LITTORAL SHELF GRAVEL

000000 SUBSTRATES ROOT MASSES OR LOG BUNDLES

COUNTY OF SIMCOE

RELOCATED DITCH ACCESS ROUTE LIMIT OF CLEARING * FOR CANAL (NOT ALWAYS SHOWN) GUIDE RAIL BELL LINE UNDER GROUNG GAS LINE PROPOSED CATCHBASIN LOCATION AND OUTLET PIPE OVERHEAD HYDRO AND POLE

HYDRO POLE (TO MOVE IF X) ANCHOR POLE (TO MOVE IF X)

CROSS-SECTION LOCATION IN FIELD AREAS IT IS LIMIT OF TOPSOIL STRIPPING

PLAN LEGEND

APPROXIMATE LOCATION AND SIZE OF EXISTING PIPE OR SLEEVE ACROSS DYNE ABOVE GRADE UNLESS NOTED AS BELOW GRADE (BG)
A2 ETC. PROPOSED NEW IRRIGATION WORK

(SEE EXTENT OF WORK NOTES RE NEW IRRIGATION WORK)

EXISTING WELL (SEE EXTENT OF WORK NOTES) NEW CANAL BANK - - - - ULTIMATE CHANNEL REQUIRED IF BRIDGE NOT REPLACED

---- PROPOSED LEVELLING AREA BOUNDARY PROPOSED TEMPORARY STRIPPED TOPSOIL STOCKPILE OR CLEARING BOUNDARY FOR LEVELLING ---- PROPOSED BUFFER FULL FULL RELOCATION OF EXISTING CANAL


PARTIAL PARTIAL RELOCATION OF EXISTING CANAL ROW RIGHT-OF-WAY PIN PROPERTY IDENTIFICATION NUMBER


HOLLAND MARSH DRAINAGE SYSTEM JOINT MUNICIPAL SERVICES BOARD TOWNSHIP OF KING AERIAL VIEW OF PROPERTIES AND EXTENT OF WORK NOTES


HOLLAND MARSH DRAINAGE SYSTEM CANAL IMPROVEMENT PROJECT


K. SMART ASSOCIATES LIMITED CONSULTING ENGINEERS AND PLANNERS 85 McINTYRE DRIVE KITCHENER, ONTARIO


JOB NUMBER 03-023 ANUARY, 2009 DRAWING NUMBE 80

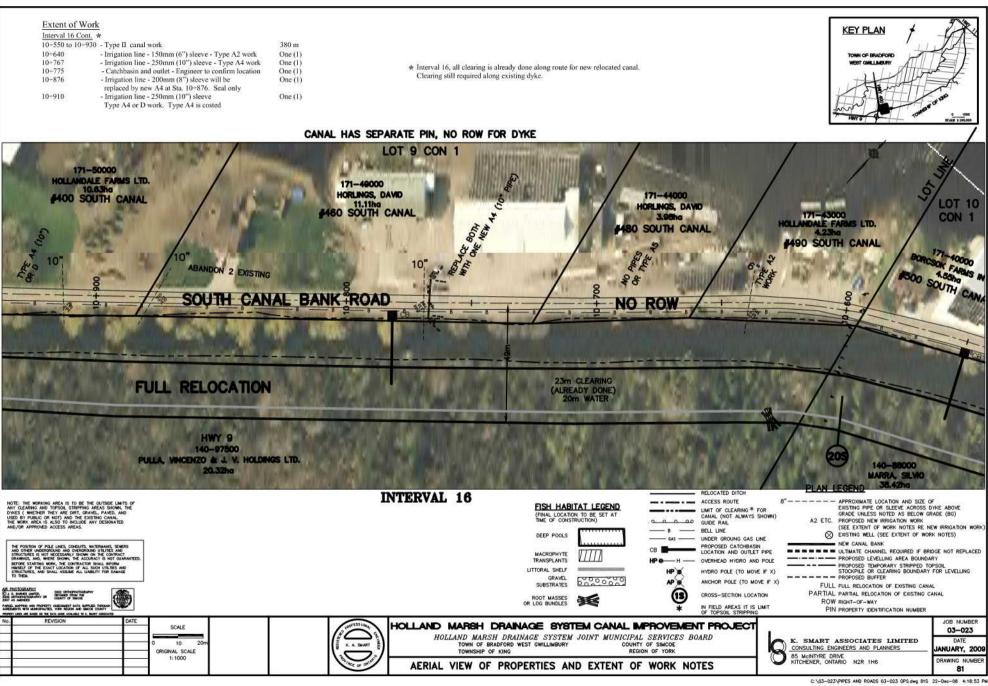


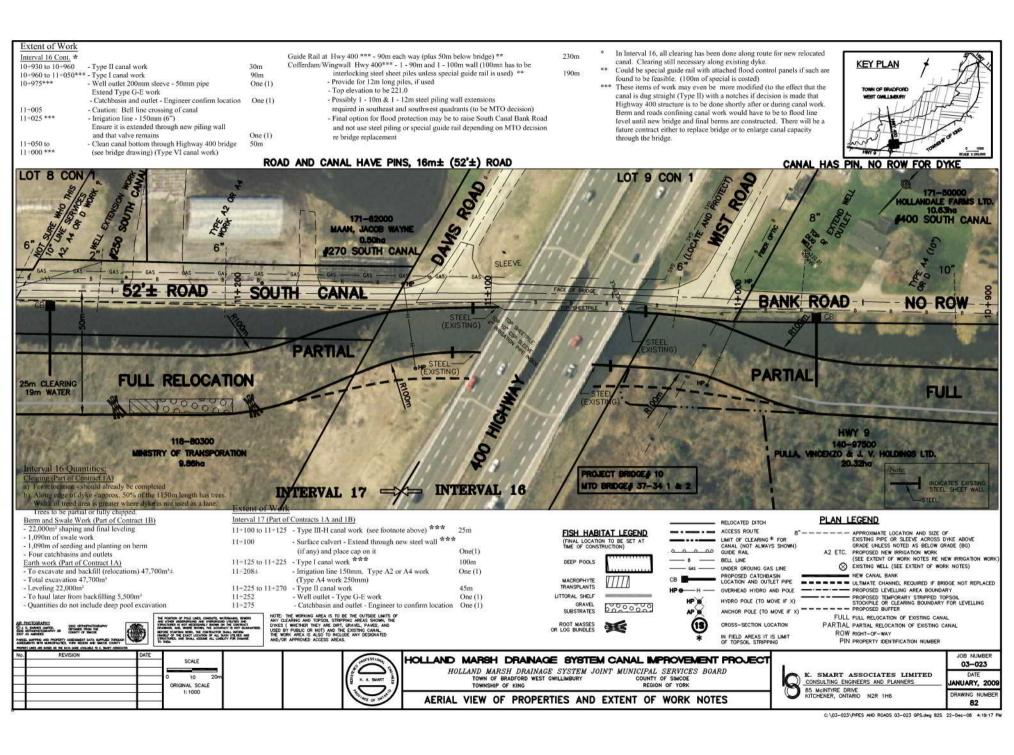

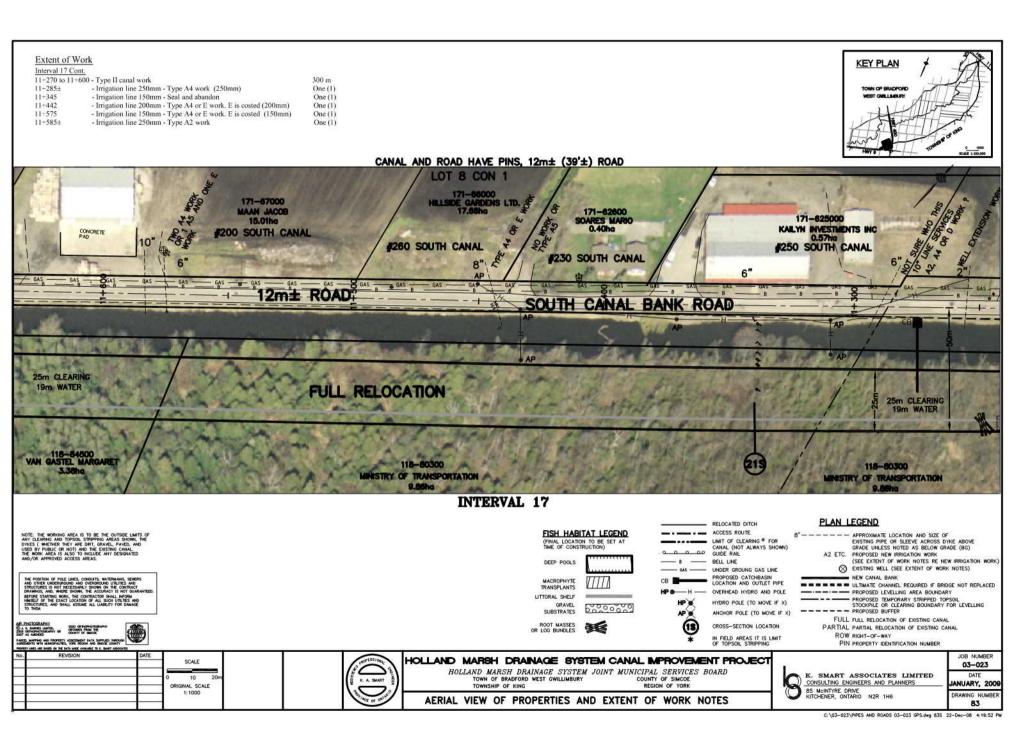

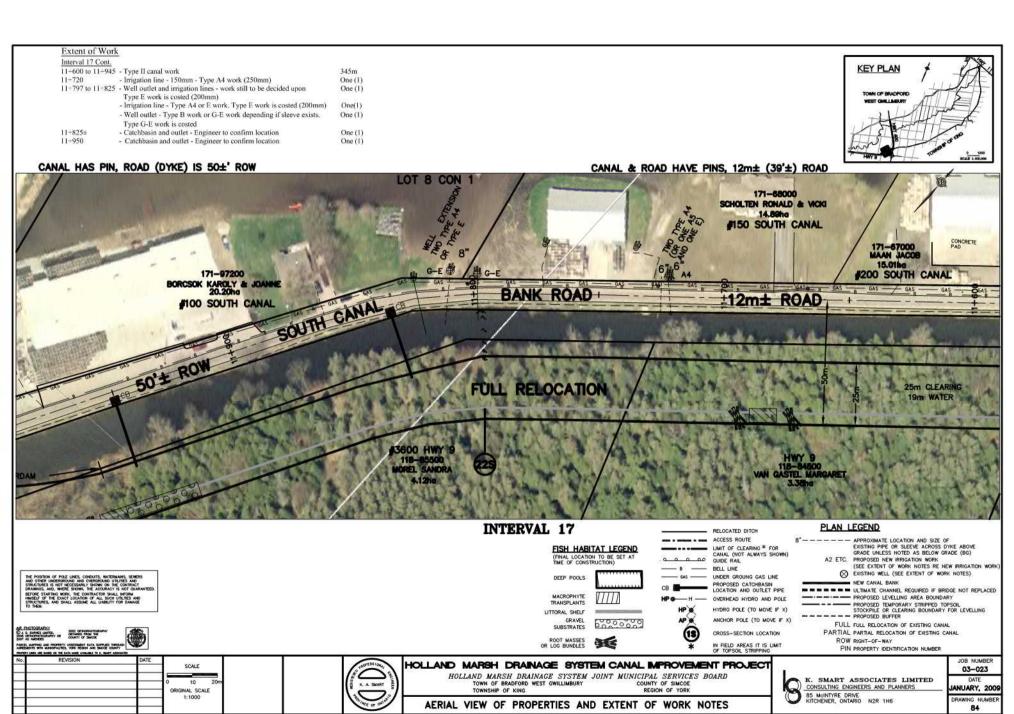

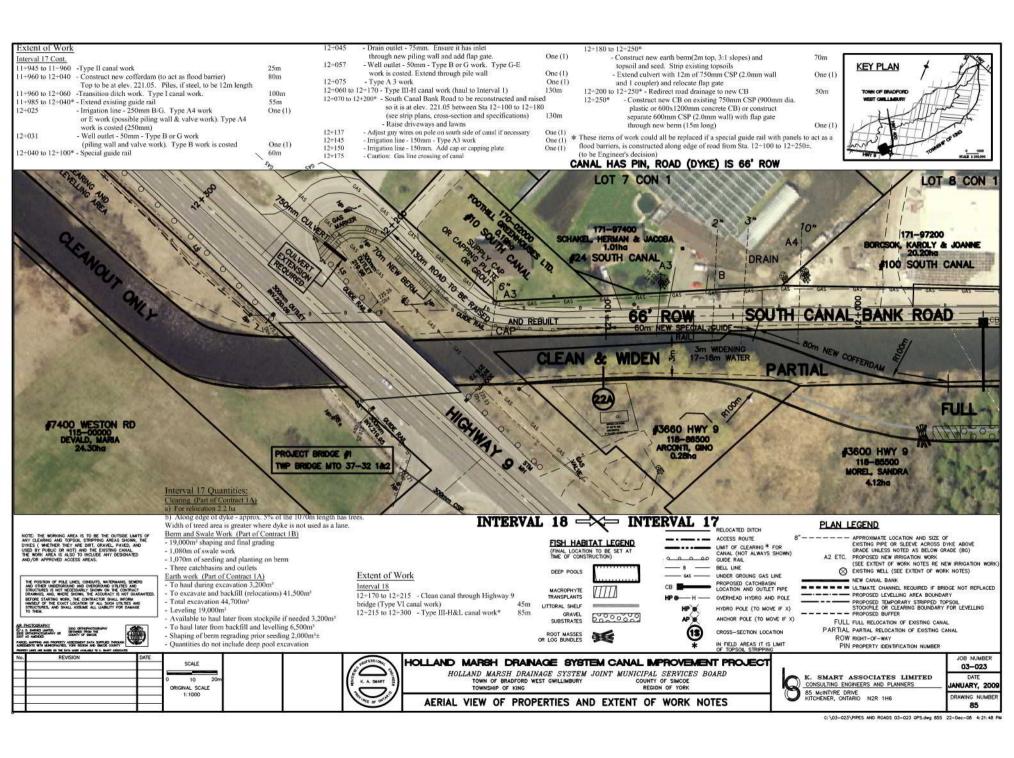

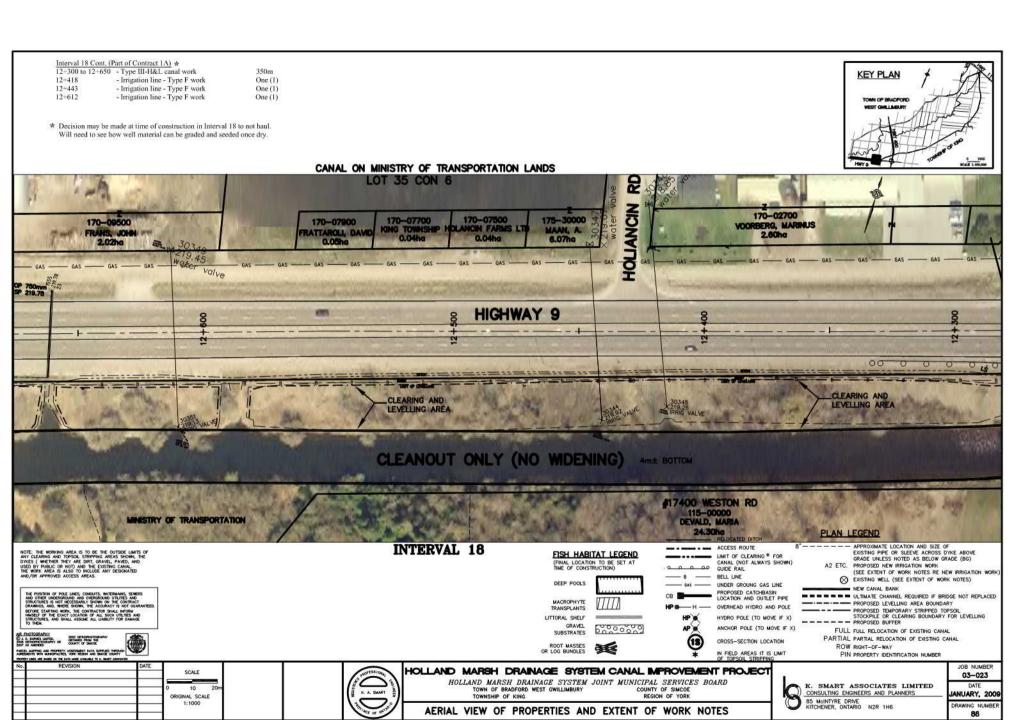

Extent of Work

Interval 18 Cont. *

12+650 to 13+000 - Type III- H&L canal work

- Existing 750mm CSP crossing Highway 9 (no work required)


12+661 12+795 - Irrigation line - Type F work

One (1) 12+877 - Irrigation line - Type F work One (1)


12+943 - Irrigation line - Type F work One (1) 12+983 - Irrigation line - Type F work One (1)

10

ORIGINAL SCALE 1:1000

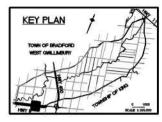

CANAL ON MINISTRY OF TRANSPORTATION LANDS

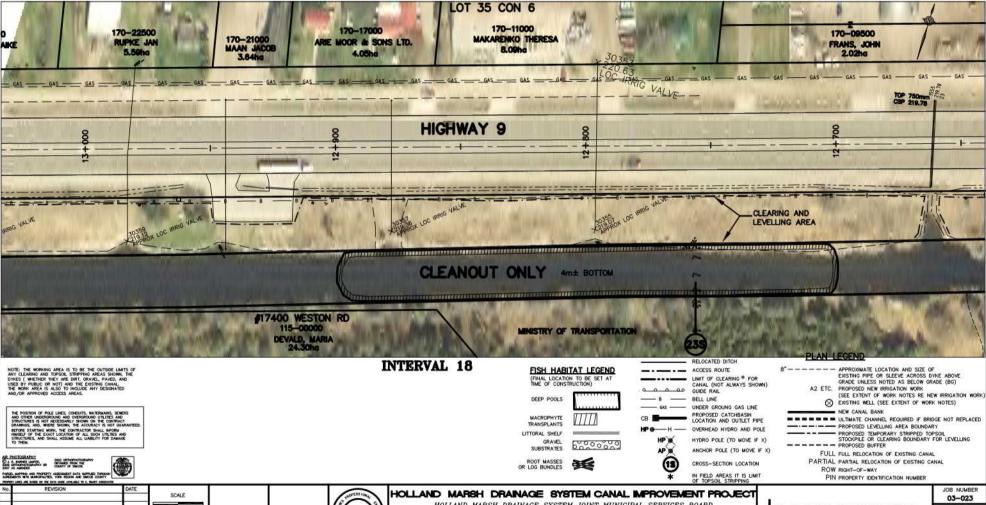


HOLLAND MARSH DRAINAGE SYSTEM JOINT MUNICIPAL SERVICES BOARD TOWN OF BRADFORD WEST GWILLIMBURY TOWNSHIP OF KING COUNTY OF SIMCOE


AERIAL VIEW OF PROPERTIES AND EXTENT OF WORK NOTES

K. SMART ASSOCIATES LIMITED CONSULTING ENGINEERS AND PLANNERS S. McINTYRE DRAW!

ANUARY, 2009 DRAWING NUMBE 87

^{*} Decision may be made at time of construction in Interval 18 to not haul. Will need to see how well material can be graded and seeded once dry.

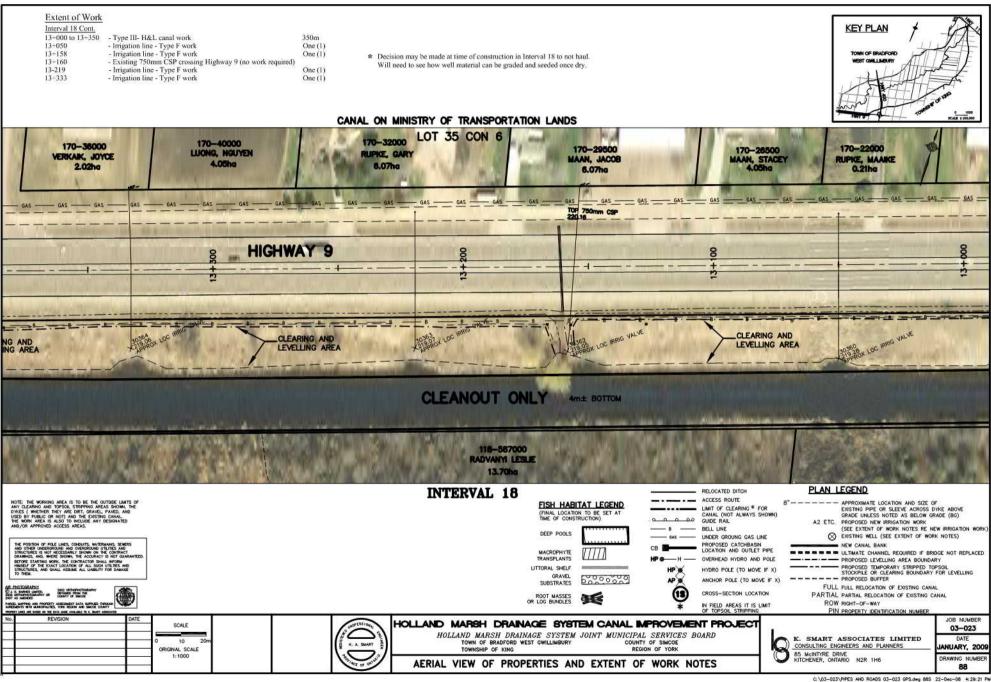

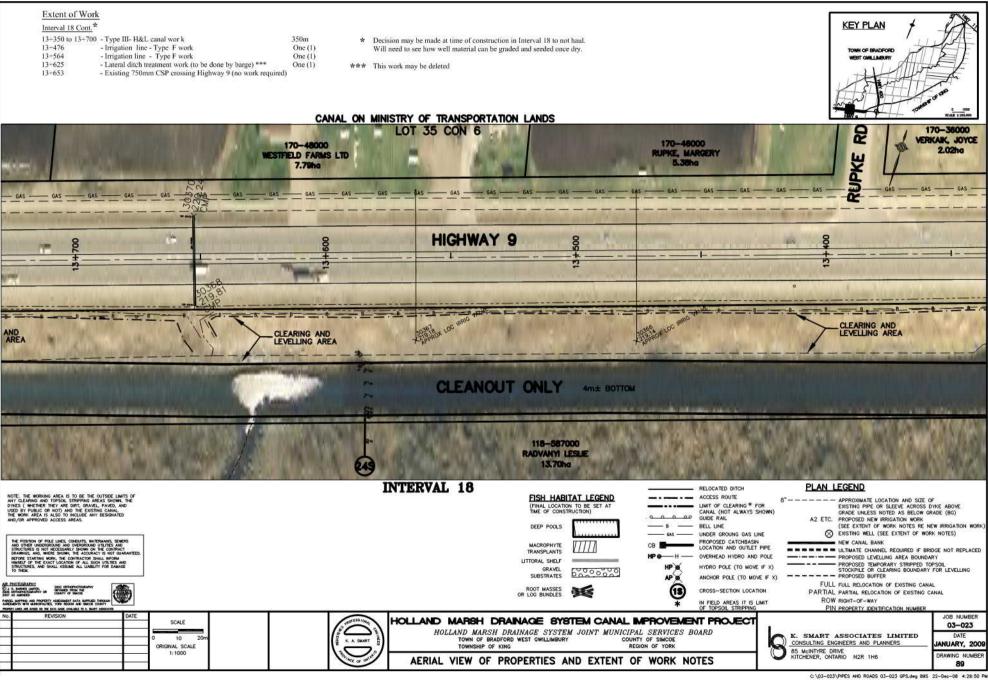

Extent of Work KEY PLAN Interval 18 Cont. * 13+700 to 14+050 - Type III- H&L canal work 350m 13+865 - Irrigation line - Type F work One (1) 13+957 - Irrigation line - Type F work One (1) * Decision may be made at time of construction in Interval 18 to not haul. Will need to see how well material can be graded and seeded once dry. CANAL ON MINISTRY OF TRANSPORTATION LANDS LOT 35 CON 6 170-53000 170-60000 MUNSHAW, THELMA 30371 218.85 LOC IRRIG VALVE CHIN DEIDRE 10.12ha 5.46ha HIGHWAY 9 AN'S CLEARING AND LEVELLING AREA CLEARING AND LEVELLING AREA CLEANOUT ONLY 118-587000 RADVANYI, LESLE 13.70ha PLAN LEGEND INTERVAL 18 RELOCATED DITCH 8"---- APPROXIMATE LOCATION AND SIZE OF EXISTING PIPE OR SLEEVE ACROSS DIVE ABOVE ORADE UNILESS NOTED AS BELOW GRADE (BG)
A2 ETC. PROPOSED NEW IRRIGATION WORK NOTE: THE MORNING AREA IS TO BE THE OUTSIDE LIMITS OF ANY CLEARING AND TOPSOL STRIPPING AREAS SHOWN, THE DIVES (WHETHER THEY ARE OUT, GRAVE), AND USED BY PUBLIC OR NOT), AND THE EXISTING CANAL. THE WORK AREA IS ALSO TO INCLUDE ANY DESIGNATED AND/OR APPROVED ACCESS AREAS. FISH HABITAT LEGEND ACCESS ROUTE LIMIT OF CLEARING * FOR CANAL (NOT ALWAYS SHOWN) (FINAL LOCATION TO BE SET AT OO GUIDE RAIL (SEE EXTENT OF WORK NOTES RE NEW IRRIGATION WORK)

EXISTING WELL (SEE EXTENT OF WORK NOTES) DEEP POOLS - BELL LINE - UNDER GROUNG GAS LINE - NEW CANAL BANK PROPOSED CATCHBASIN LOCATION AND OUTLET PIPE MACROPHYTE - - - - - ULTIMATE CHANNEL REQUIRED IF BRIDGE NOT REPLACED TRANSPLANTS OVERHEAD HYDRO AND POLE LITTORAL SHELF PROPOSED TEMPORARY STRIPPED TOPSOIL STOCKPILE OR CLEARING BOUNDARY FOR LEVELLING HP . HYDRO POLE (TO MOVE IF X) GRAVEL 5000000 ---- PROPOSED BUFFER AP & ANCHOR POLE (TO MOVE IF X) FULL FULL RELOCATION OF EXISTING CANAL (13 ROOT MASSES OR LOG BUNDLES PARTIAL PARTIAL RELOCATION OF EXISTING CANAL CROSS-SECTION LOCATION ROW RIGHT-OF-WAY PARCEL MAPPING AND PROPERTY ASSESSMENT SATA SUPPLIED THROUGH AGRESSMENTS WITH MARKSPALLTES, YORK RECOON AND SMICH COUNTY IN FIELD AREAS IT IS LIMIT OF TOPSOIL STRIPPING PIN PROPERTY IDENTIFICATION NUMBER

HOLLAND MARSH DRAINAGE SYSTEM CANAL IMPROVEMENT PROJECT

HOLLAND MARSH DRAINAGE SYSTEM JOINT MUNICIPAL SERVICES BOARD

AERIAL VIEW OF PROPERTIES AND EXTENT OF WORK NOTES

COUNTY OF SIMCOE

TOWN OF BRADFORD WEST GWILLIMBURY TOWNSHIP OF KING

REVISION

SCALE

10

ORIGINAL SCALE

1:1000

JOB NUMBER

03-023


ANUARY, 2009


90


DRAWING NUMBE


K. SMART ASSOCIATES LIMITED CONSULTING ENGINEERS AND PLANNERS S. McINTYRE DRAW!

85 McINTYRE DRIVE KITCHENER, ONTARIO

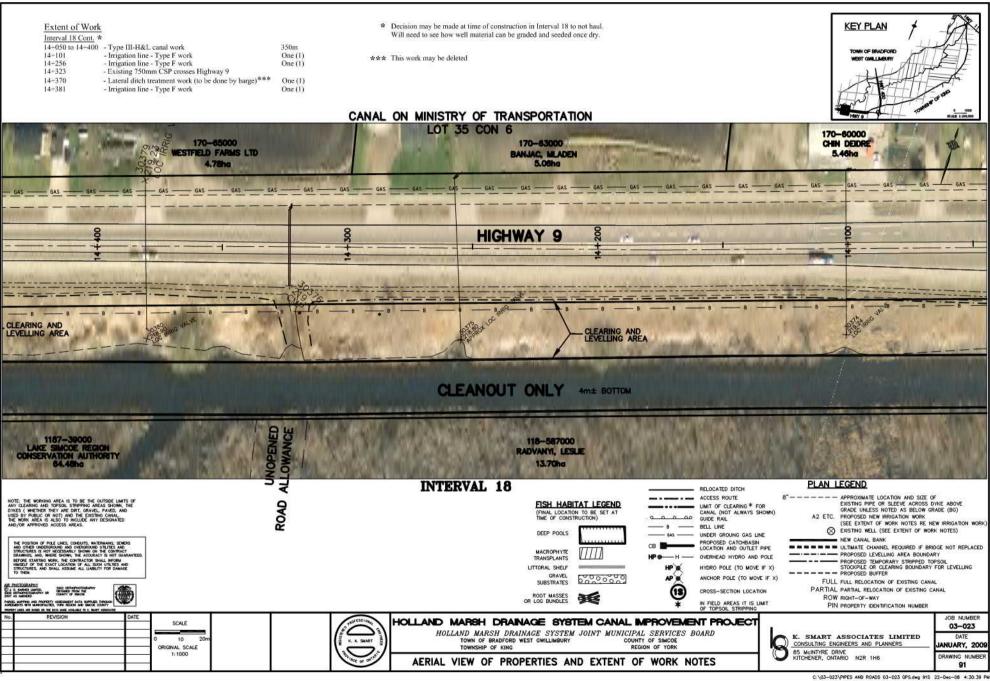

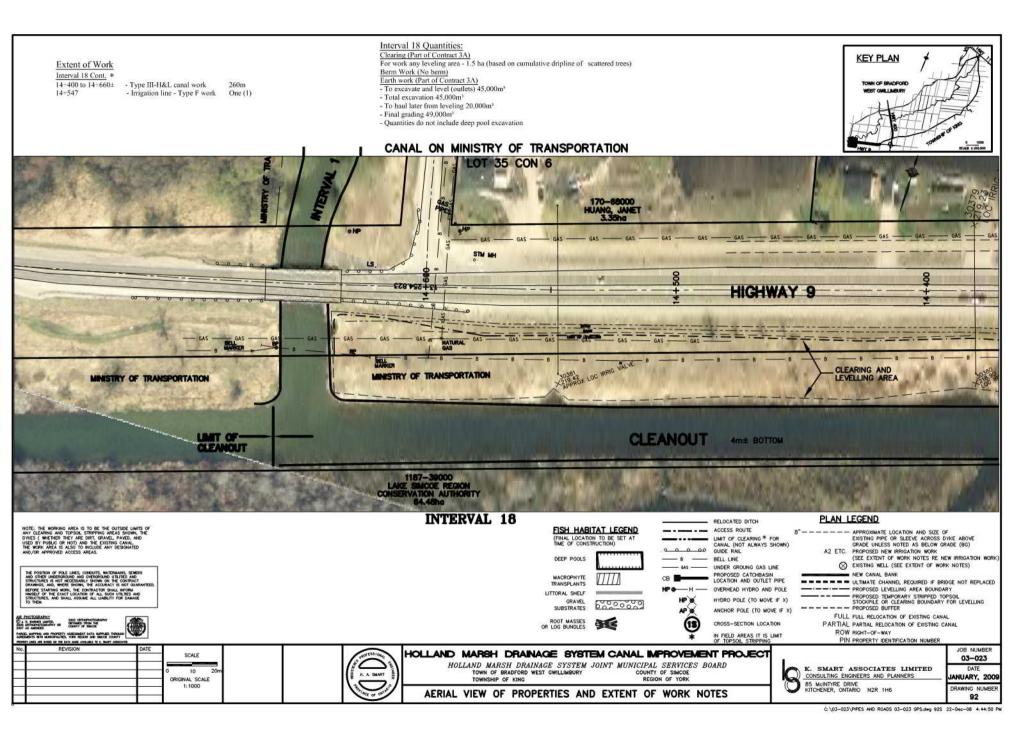

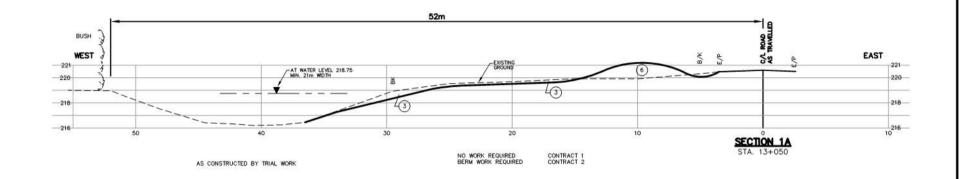


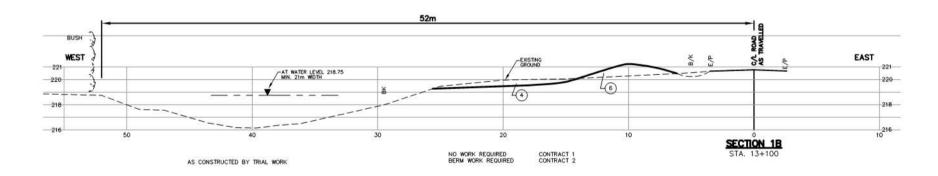


NORTH CANAL Interval 1

- -Full relocation with earth berm
 -Clean through one bridge
 -Enlarge or replace same bridge later
 -Improve or remove one private bridge

DRAWN BY: NAB. DRAWN BY: NAB.	Е		CHECKED BY: KAS.	PROFILE HOR 1: 200 VERT 1: 200	TOWNSHIP OF KING REGION OF YORK SECTIONS 1A & 1B	DRAWING NUMBER
	INC	REVISION DATE	DESIGNED BY: K.A.S. CHECKED BY: K.A.S.	SCALE	HOLLAND MARSH DRAINAGE SYSTEM CANAL IMPROVEMENT PROJECT HOLLAND MARSH DRAINAGE SYSTEM JOINT MUNICIPAL SERVICES BOARD	03-023

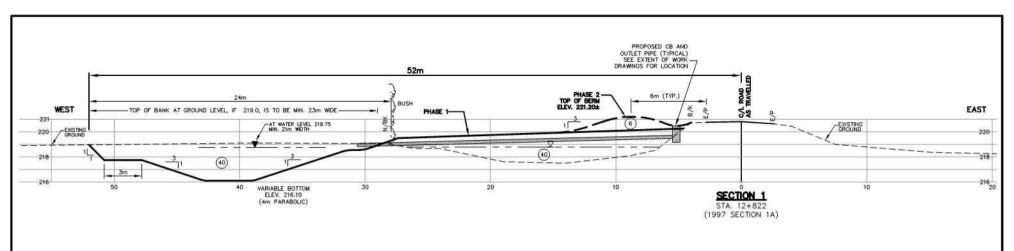

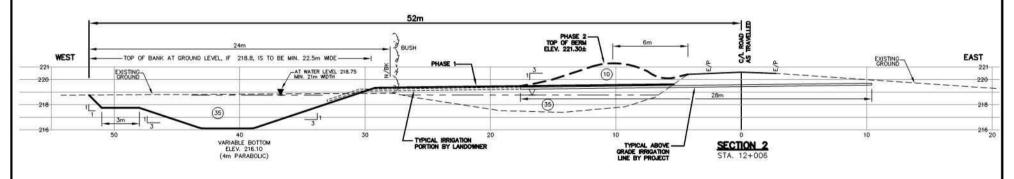

NOTES:

1, CROSS SECTION FOR FULLY RELOCATED NEW CHANNEL AS SHOWN AT STA. 12+006 IS TYPICAL FROM STA. 12+900 TO 9+670 WHENEVER FULL RELOCATION IS TO OCCUR 2. BACK SLOPE OF LITTORAL SHELF TO BE 1:1 AND SHELF TO BE 3m WIDE 3. ROAD CROSS SECTION MAY CHANGE WITH RE DESIGN OF THE PROPERTY.

THE ROAD 4. PORTION FROM 13+200 TO 12+950 IS ALREADY CONSTRUCTED, SOME WIDENING IS NECESSARY AS SHOWN

NORTH CANAL Interval 1

- -Full relocation with earth berm -Clean through one bridge -Enlarge or replace same bridge later -Improve or remove one private bridge

DESIGNED DI. RASI	SCALE		
CHECKED BY: K.A.S.			
DRAWN BY: N.M.B.	PROFILE		
CHECKED BY: KAS.	HOR 1: 200 VERT 1: 200		
FIELD BOOK:			

DATE DESIGNED BY WAS


HOLLAND MARSH DRAINAGE SYSTEM CANAL IMPROVEMENT PROJECT HOLLAND MARSH DRAINAGE SYSTEM JOINT MUNICIPAL SERVICES BOARD TOWN OF BRADFORD WEST GWILLIMBURY
TOWNSHIP OF KING COUNTY OF SIMCOE REGION OF YORK


SECTIONS 1 AND 2

K. SMART ASSOCIATES LIMITED CONSULTING ENGINEERS AND PLANNERS 85 MCINTYRE DRIVE HOLERRY OUTSIDE HOLERRY OUTSID 85 McINTYRE DRIVE KITCHENER, ONTARIO N2R 1H6

JOB NUMBER 03-023 JANUARY, 2009

C: \03-023\NORTH SECTION 03-023.dwg 1 2 24-Dec-08 11:50:00 AM

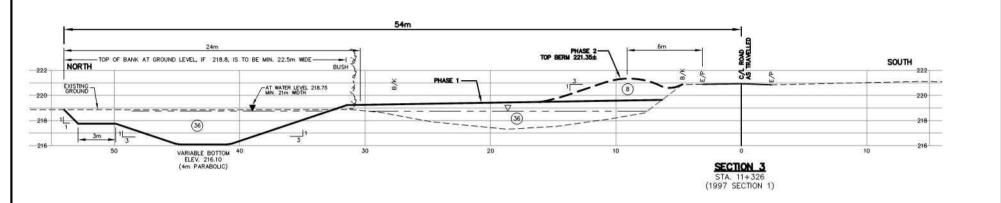

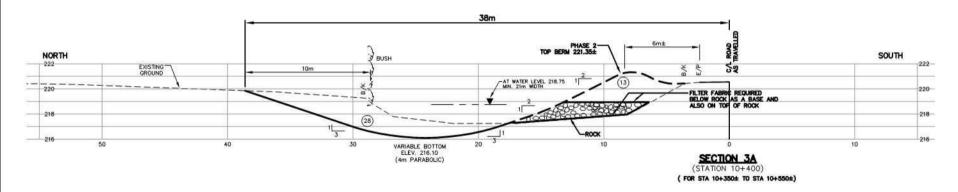

SLOPE FOR ROCK AND FILL IS 2:1 SLOPE FOR CUT BELOW IS 3:1

NOIS: 1. CROSS SECTION FOR FULLY RELOCATED NEW CHANNEL AS SHOWN AT STA. 12+006 IS TYPICAL FROM STA. 12+900 TO 9+670 WHENEVER FULL RELOCATION IS TO OCCUR 2. BACK SLOPE OF LITTORAL SHELF TO BE 1:1 AND SHELF TO BE 3m WIDE 3. ROAD CROSS SECTION MAY CHANGE WITH RE DESIGN OF

THE ROAD PORTION FROM 13+200 TO 12+950 IS ALREADY CONSTRUCTED, SOME WIDENING IS NECESSARY AS SHOWN NOTE RE QUANTITIES FOR INTERVAL 1 (CONTRACT IA)

- TO HAUL DURING EXCAVATION 3,500cu.m.

- TO EXCAVATE & LEVEL 89,500cu.m.

- TOTAL EXCAVATION 93,000cu.m.

- TOTAL EXCAVATION - HAUL IN FOR BERM - GRADING BEFORE BERM 23,500cu.m.±

1.000cu.m. - RELEVELLING 10,000sq.m.

NORTH CANAL Interval 1

-Full relocation with earth berm -Clean through one bridge -Enlarge or replace same bridge later -Improve or remove one private bridge

No.	REVISION	DATE	DESIGNED BY: KAS.	SCALE
		-	CHECKED BY: K.A.S.	
			DRAWN BY: N.M.B.	0 2 4 PROFILE
-			CHECKED BY: KAS.	HOR 1: 200 VERT 1: 200
-			FIELD BOOK:	

HOLLAND MARSH DRAINAGE SYSTEM CANAL IMPROVEMENT PROJECT HOLLAND MARSH DRAINAGE SYSTEM JOINT MUNICIPAL SERVICES BOARD COUNTY OF SIMCOE

TOWN OF BRADFORD WEST GWILLIMBURY
TOWNSHIP OF KING REGION OF YORK


SECTIONS 3 AND 3A




K. SMART ASSOCIATES LIMITED
CONSULTING ENGINEERS AND PLANNERS
85 MCINTYRE DRIVE
KITCHEREP CHIEFE 85 McINTYRE DRIVE KITCHENER, ONTARIO N2R 1H6

JOB NUMBER 03-023 JANUARY, 2009

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SECTIONS 6 AND 7

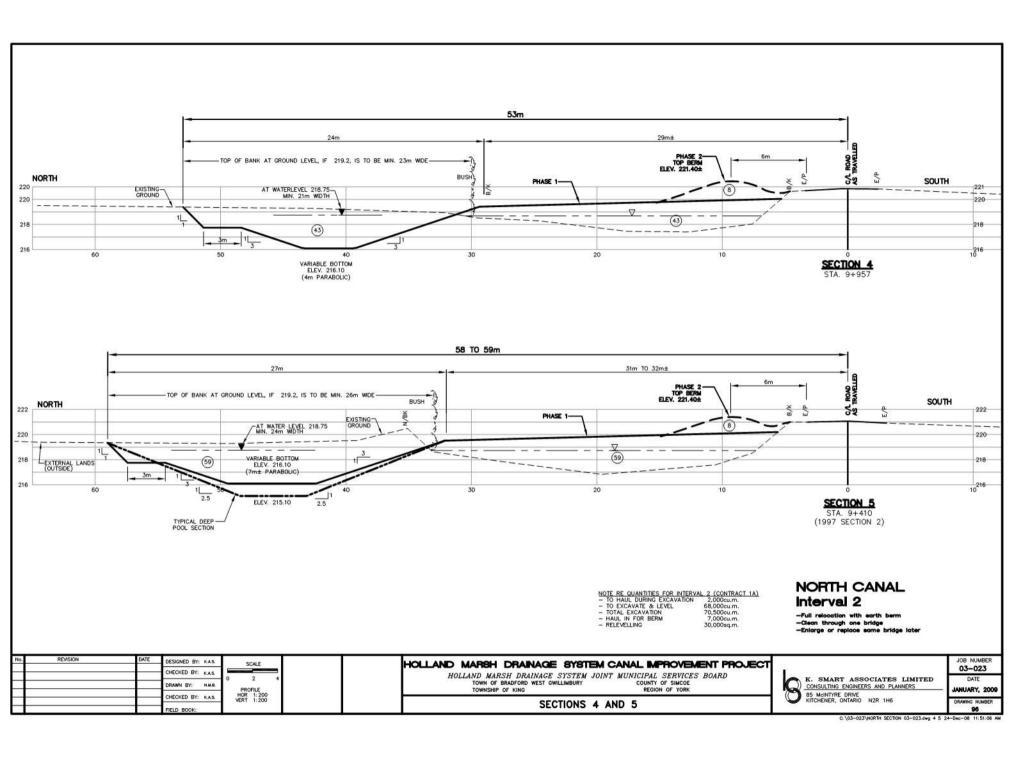
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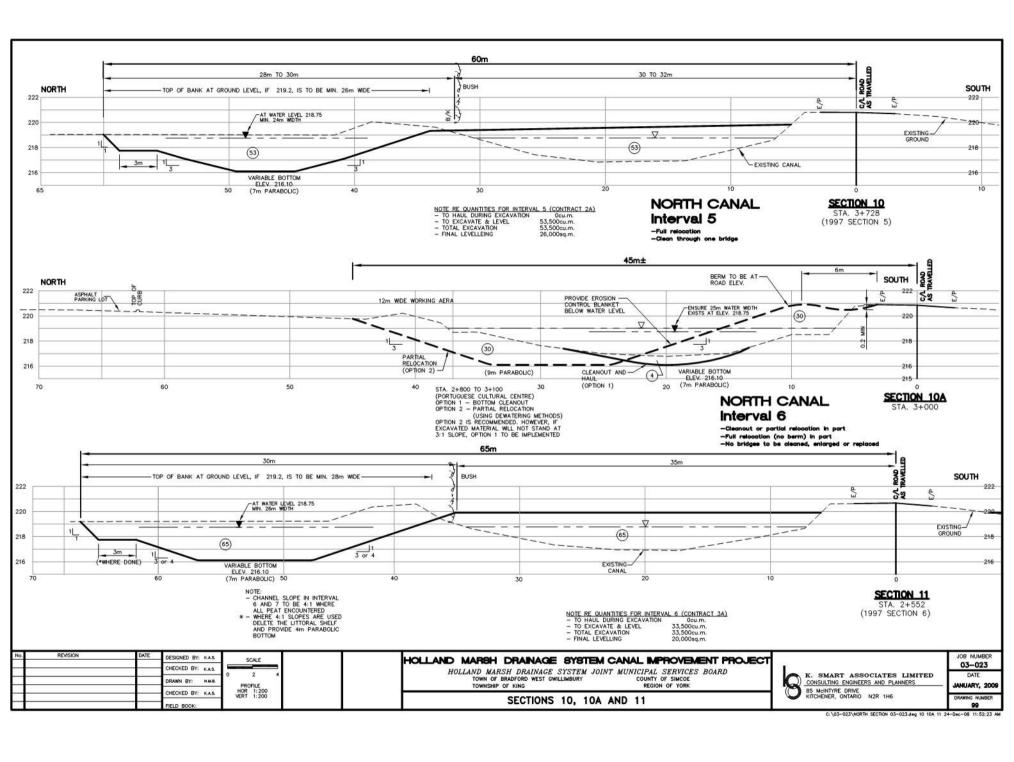
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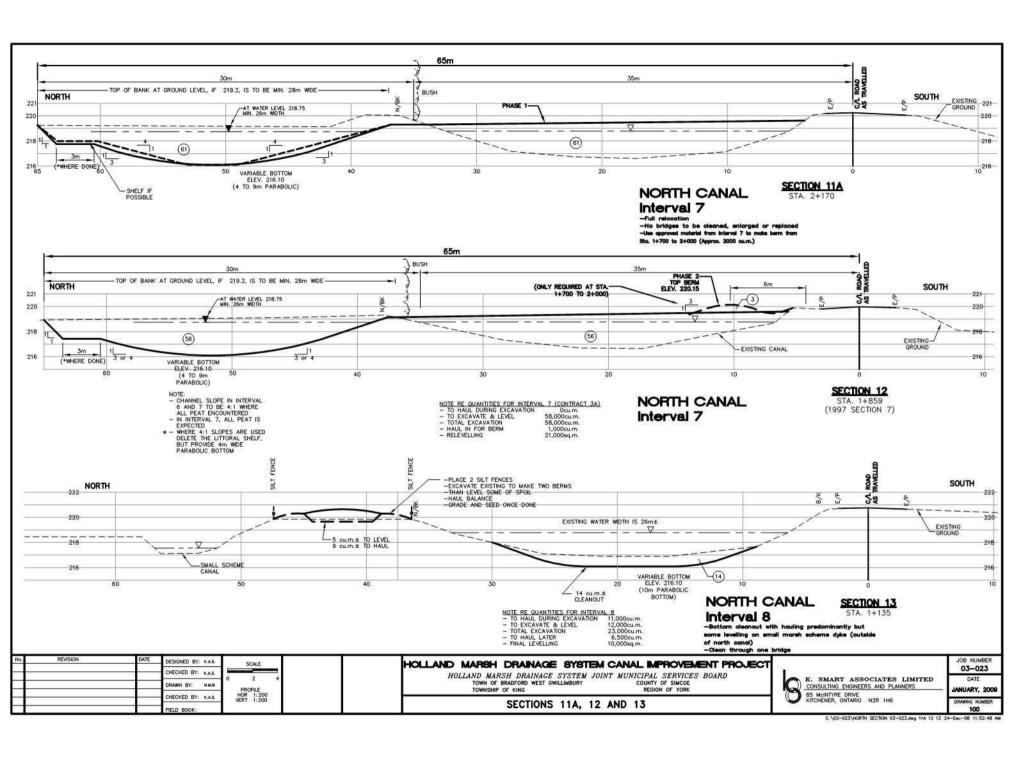
85 McINTYRE DRIVE KITCHENER, ONTARIO N2R 1H6

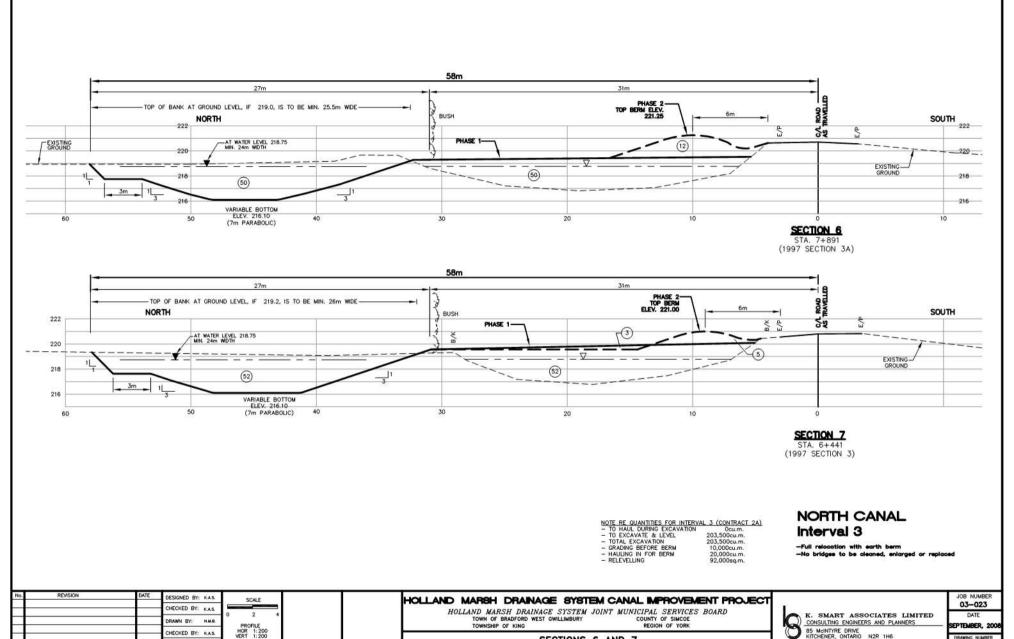
EPTEMBER, 200


97





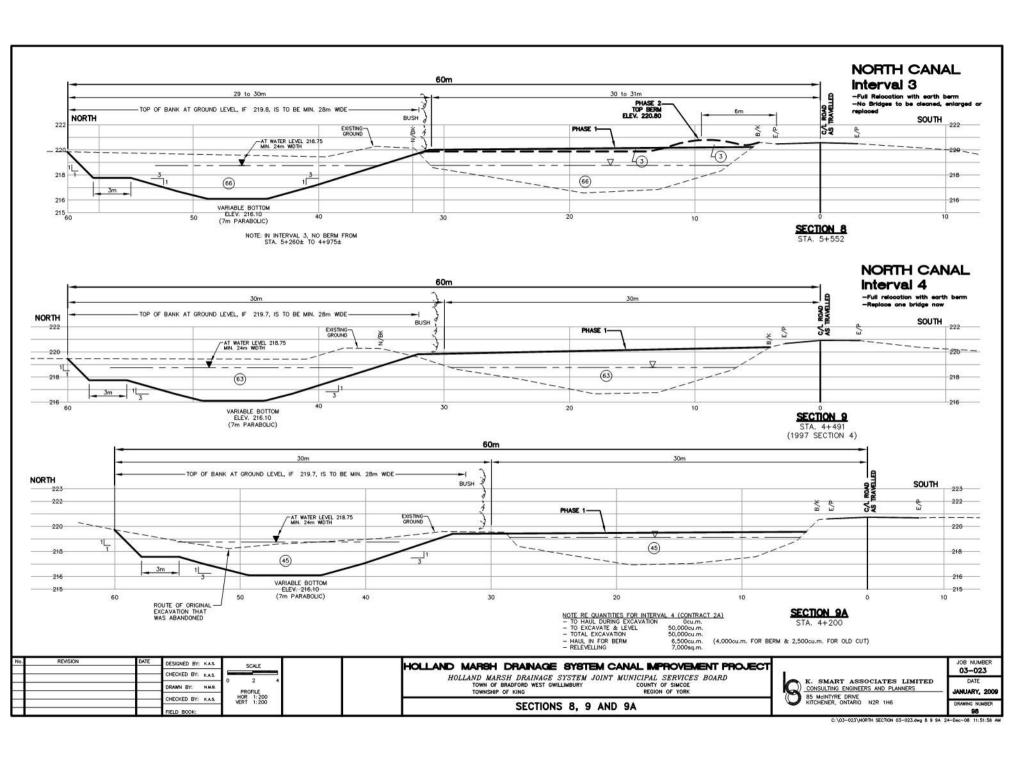

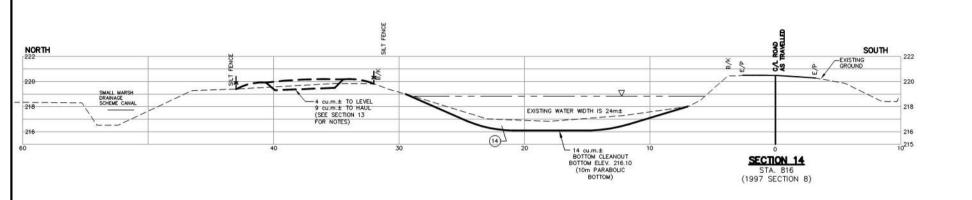


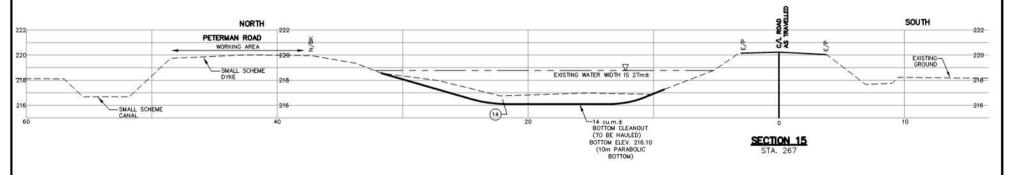


NORTH CANAL

Interval 8
-Bottom cleanout with hauling predominantly but some levelling on small marsh scheme dyke (outside of north canal)
-Clean through one bridge


CHECKED BY: K.A.S. DRAWN BY: N.M.B. 0	2 4	HOLLAND MARSH DRAINAGE SYSTEM CANAL IMPROVEMENT PROJECT HOLLAND MARSH DRAINAGE SYSTEM JOINT MUNICIPAL SERVICES BOARD TOWN OF BRADFORD WEST GWILLINBURY COUNTY OF SINGED	K. SMART ASSOCIATES LIMITED	03-023 DATE
CHECKED BY: KAS. M	PROFILE HOR 1:200 ERT 1:200	TOWNSHIP OF KING REGION OF YORK SECTIONS 14, 15	85 McINTYRE DRIVE	DRAWING NUMBER 101

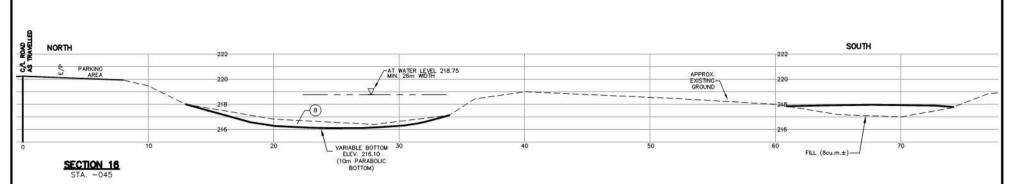


NORTH CANAL Interval 8

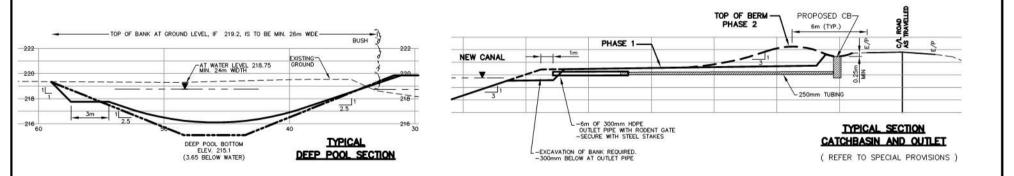

No. RE	CHI DRI	SIGNED BY: K.A.S. IECKED BY: K.A.S. WWN BY: N.M.B.	SCALE 0 2 4 PROFILE		HOLLAND MARSH DRAINAGE SYSTEM CANAL IMPROVEMENT PROJECT HOLLAND MARSH DRAINAGE SYSTEM JOINT MUNICIPAL SERVICES BOARD TOWN OF BRADFORD WEST GWILLIMBURY REGION OF YORK		K. SMART ASSOCIATES LIMITED	JOB NUMBER 03-023 DATE JANUARY, 2009
		ECKED BY: KAS.	HOR 1: 200 VERT 1: 200		NEW SECTIONS	O &	85 McINTYRE DRIVE KITCHENER, ONTARIO N2R 1H6 C:\03-023\north SECTION 03-023.dwg 16 & TYPICAL 24-	DRAWING NUMBER 102

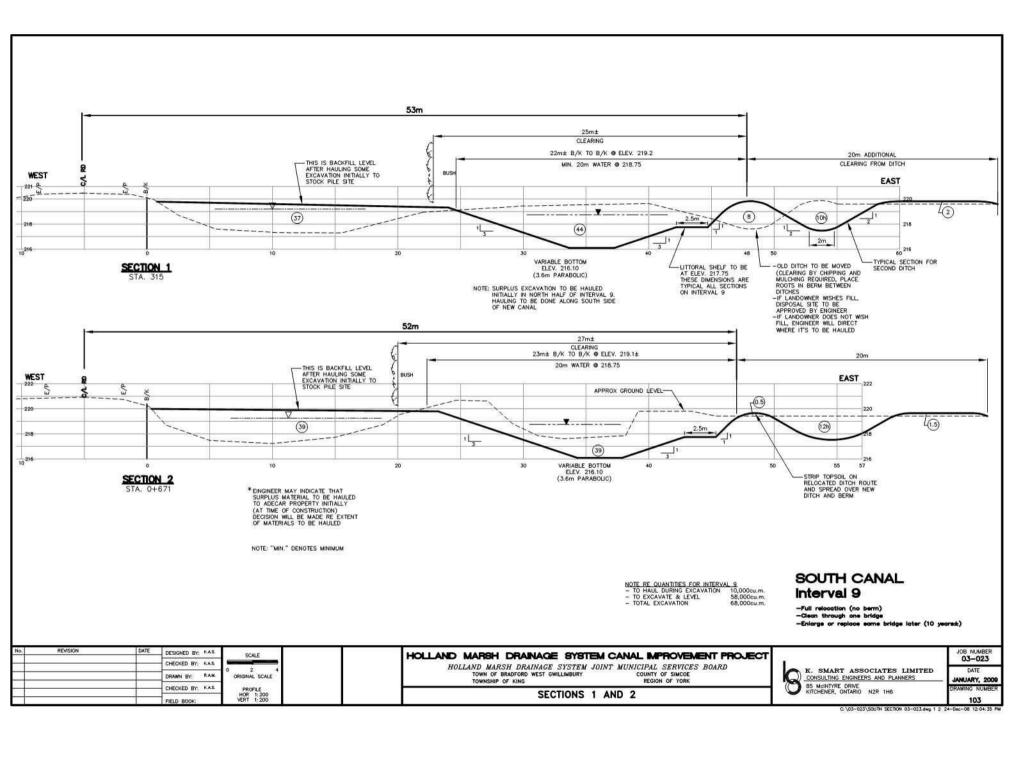


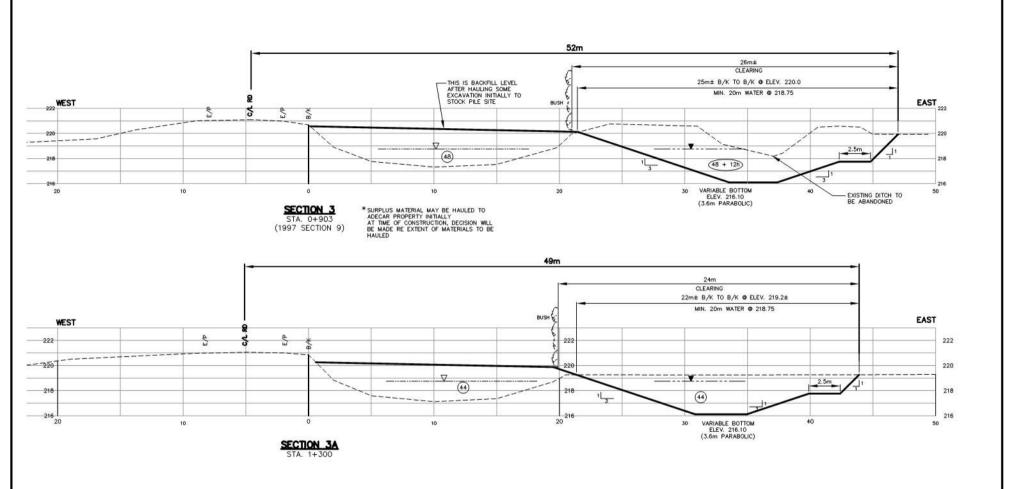



SOUTH CANAL Interval 9

- -Full relocation (no berm)
 -Clean through one bridge
 -Enlarge or replace same bridge later (10 years±)

No. REVISION DATE DESIGNED BY: KAS. CHECKED BY: KAS. DRAWN BY: RAM.	SCALE 0 2 4 ORIGINAL SCALE	HOLLAND MARSH DRAINAGE SYSTEM CANAL IMPROVEMENT PROJECT HOLLAND MARSH DRAINAGE SYSTEM JOINT MUNICIPAL SERVICES BOARD TOWN OF BRADFORD WEST GWILLIMBURY TOWNSHIP OF KINGE EGION OF YORK	K. SMART ASSOCIATES LIMITED CONSULTING ENGINEERS AND PLANNERS	JOB NUMBER 03-023 DATE JANUARY, 2009
CHECKED BY: KAS.	PROFILE HOR 1:200	SECTIONS 3 AND 3A		DRAWING NUMBER
FIELD BOOK:	VERT 1: 200	SECTIONS 5 AND 5A	C\01_023\S0HTH SECTION 03_023 dec 3 % 2	104

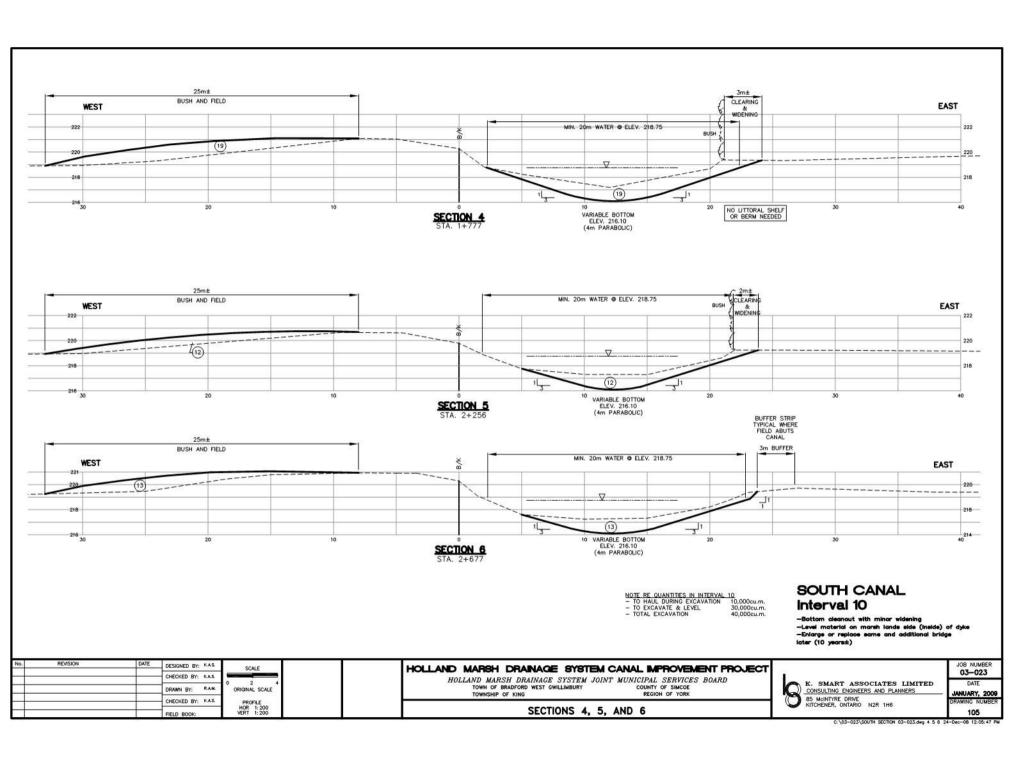


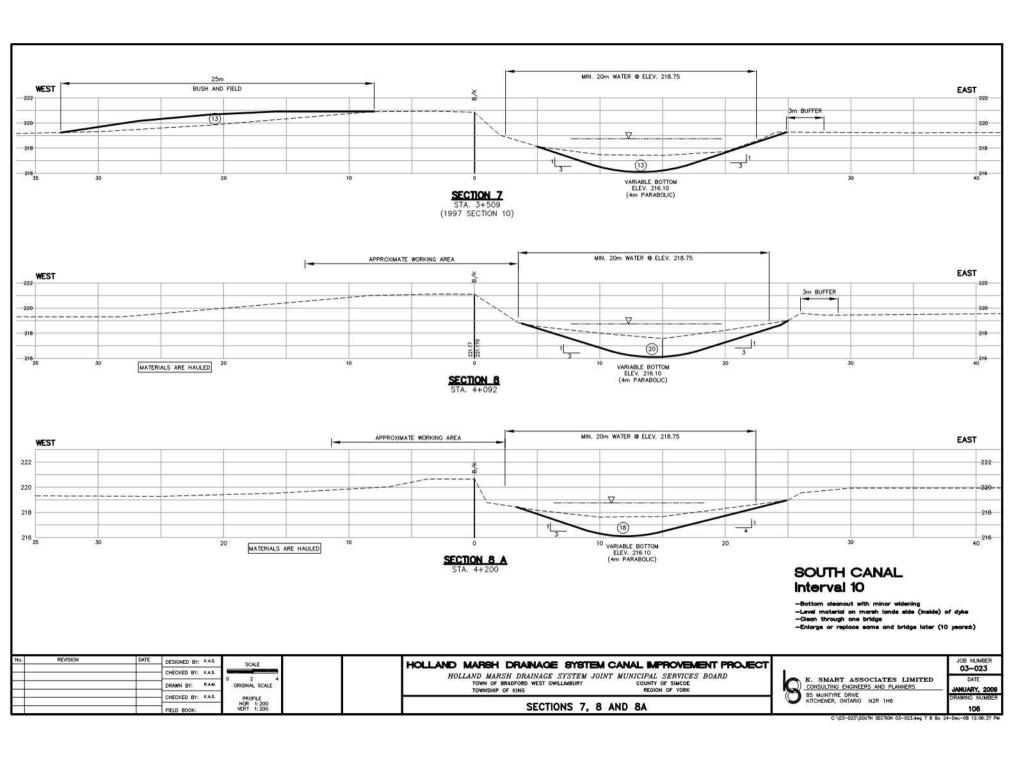

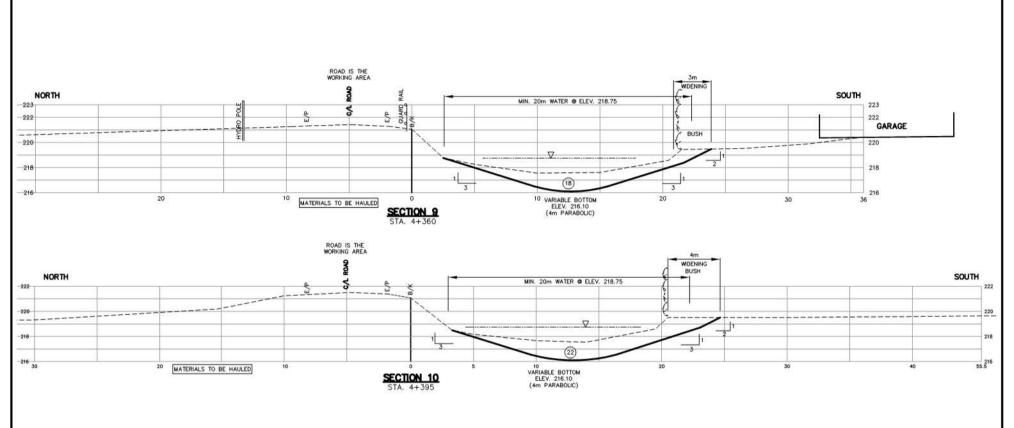

SOUTH CANAL Interval 11

No. REVISION DATE DESIGNED BY: KAS. CHECKED BY: KAS. DRAWN BY: RAM.	SCALE 0 2 ORIGINAL SCALE	HOLLAND MARSH DRAINAGE SYSTEM CANAL IMPROVEMENT PROJECT HOLLAND MARSH DRAINAGE SYSTEM JOINT MUNICIPAL SERVICES BOARD TOWN OF BRADFORD WEST GWILLIMBURY TOWNSHIP OF KING REGION OF YORK		JOB NUMBER 03-023 DATE JANUARY, 2009
CHECKED BY: K.A.S. FIELD BOOK:	PROFILE HOR 1: 200 VERT 1: 200	PROFILE HOR 1:200 SECTIONS 9 AND 10	KITCHENER, ONTARIO N2R 1H6	DRAWING NUMBER

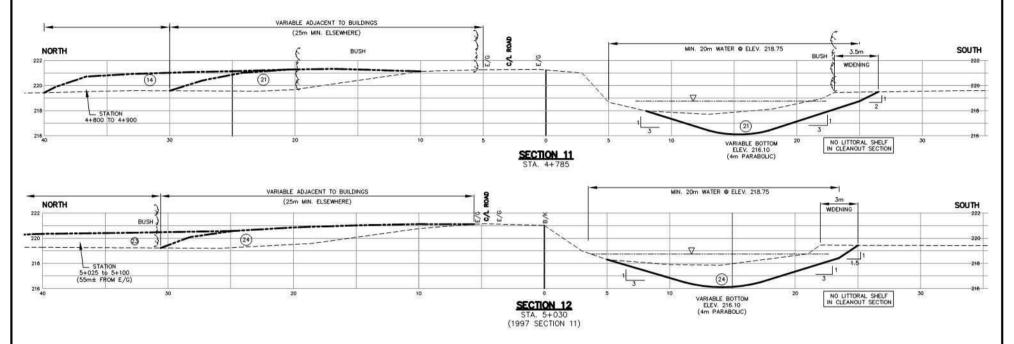

NO SECTION 13

| NOTE RE QUANTITIES FOR INTERVAL 11 | - TO HAUL DURING EXCAVATION | 6,500cu.m. + TO TAL EXCAVATION | 36,500cu.m. * TOTAL EXCAVATION | 36,500cu.m. * 36,500c

* OF THIS, APPROXIMATELY 8,000cu.m. TO BE HAULED/MOVED LATERALLY DUE TO BUILDING
AREAS PRIOR TO LEVELING. THIS IS IN ADDITION
TO THE 6,500cu.m. FROM THE ROAD AREA

SOUTH CANAL Interval 11

-Bottom cleanout with minor widening, hauling by road -Level material on marsh lands side (inside) of dyke elsewhere -No bridges to be cleaned, enlarged or replaced

No.	REVISION	DATE	DESIGNED BY: KAS	SCALE
-		_	CHECKED BY: K.A.S.	——
		DRAWN BY: RAM	ORIGINAL SCALE	
		-+-	CHECKED BY: K.A.S.	PROFILE
	- 1	FIELD BOOK:	HOR 1: 200 VERT 1: 200	

HOLLAND MARSH DRAINAGE SYSTEM CANAL IMPROVEMENT PROJECT HOLLAND MARSH DRAINAGE SYSTEM JOINT MUNICIPAL SERVICES BOARD


TOWN OF BRADFORD WEST GWILLIMBURY
TOWNSHIP OF KING COUNTY OF SIMCOE


SECTIONS 11 AND 12

0	K. SMART ASSOCIATES LIMITED CONSULTING ENGINEERS AND PLANNERS
O	85 McINTYRE DRIVE


03-023 JANUARY, 2009 108


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No.	REVISION	DATE	DESIGNED BY: K.A.S. CHECKED BY: K.A.S. DRAWN BY: R.A.M.	SCALE 0 2 4 ORIGINAL SCALE			HOLLAND MARSH DRAINAGE SYSTEM CANAL IMPROVEMENT PROJECT HOLLAND MARSH DRAINAGE SYSTEM JOINT MUNICIPAL SERVICES BOARD TOWN OF BRAFFORD WEST GWILLINBURY TOWNSHIP OF KING REGION OF YORK REGION OF YORK	K. SMART ASSOCIATES LIMITED CONSULTING ENGINEERS AND PLANNERS	JOB NUMBER 03-023 DATE JANUARY, 2009
			CHECKED BY: K.A.S.	PROFILE HOR 1:200		I F	SECTIONS 16 AND 17	85 McINTYRE DRIVE KITCHENER, ONTARIO N2R 1H6	DRAWING NUMBER
			FIELD BOOK:	VERT 1: 200	T 1:200		SECTIONS TO AND TY	C:\03-023\500TH SECTION 03-023.dwg 16 17 24	110 -040-08 12:08:49 PM

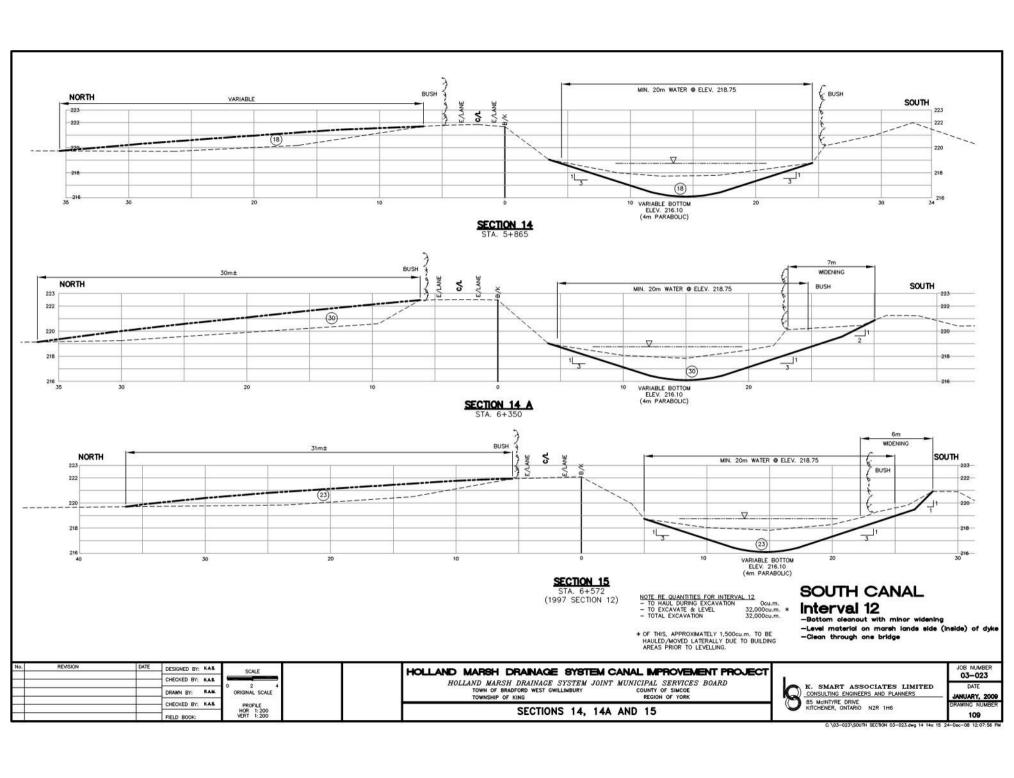

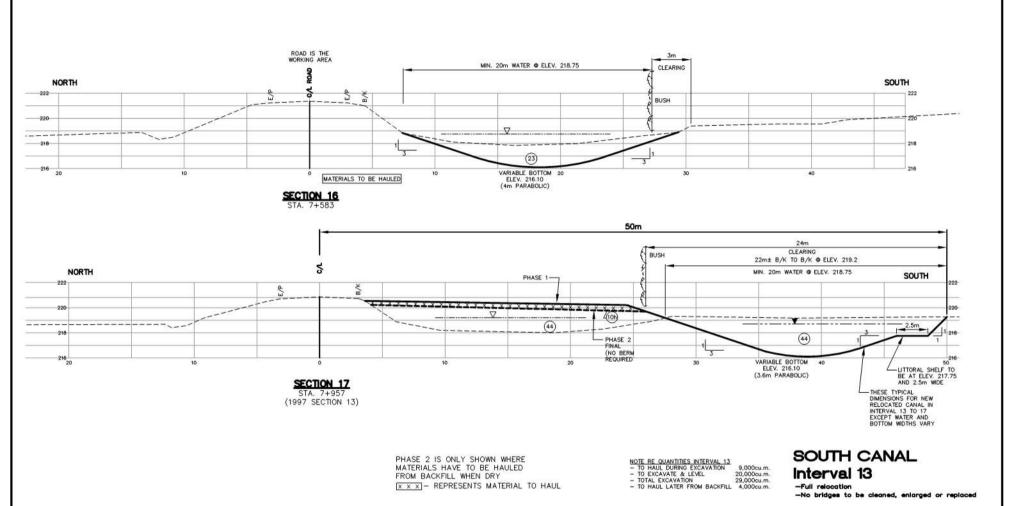

NOTE: IN INTERVALS 14 & 15, NO BERM IS TO BE BUILT BUT THE EARTH DYKE AND GRANULAR ROAD ARE TO BE RAISED TO ELEVATIONS SHOWN

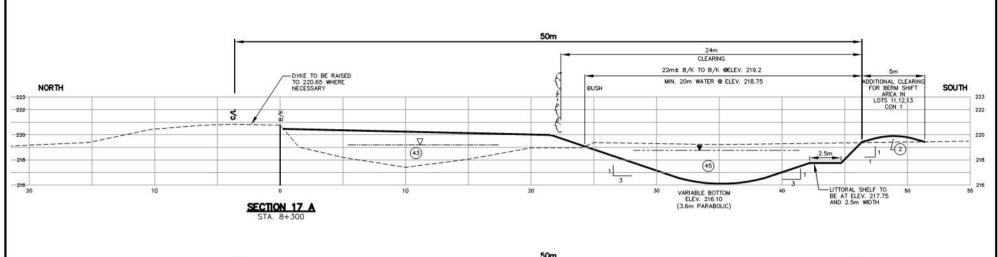Interval 14
-Full relocation with dyke raising where necessary

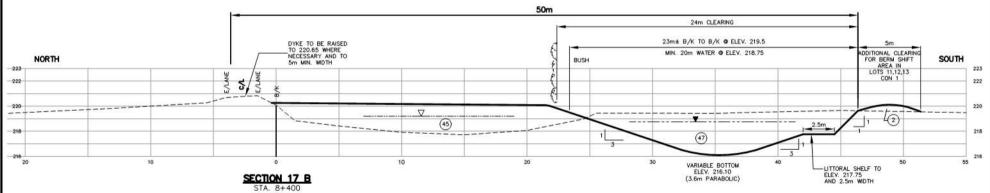No bridges to be cleaned, enlarged or replaced

No.	REVISION	DATE	DESIGNED BY: K.A.S.	SCALE
		_	CHECKED BY: KAS.	
			DRAWN BY: RAM.	ORIGINAL SCALE
-			CHECKED BY: KAS.	PROFILE
			FIELD BOOK:	HOR 1: 200 VERT 1: 200

HOLLAND MARSH DRAINAGE SYSTEM CANAL IMPROVEMENT PROJECT
HOLLAND MARSH DRAINAGE SYSTEM JOINT MUNICIPAL SERVICES BOARD
TOWN OF BRADFORD WEST GWILLIMBURY
TOWNSHIP OF KING
REGION OF YORK

SECTION 17A AND 17B

K. SMART ASSOCIATES LIMITED
CONSULTING ENGINEERS AND PLANNERS
85 MCINTYRE DRIVE
KITCHERE, ONTARIO NZR 1H6


SOUTH CANAL


JOB NUMBER
03-023


DATE
JANUARY, 2009

DRAWING NUMBER
111


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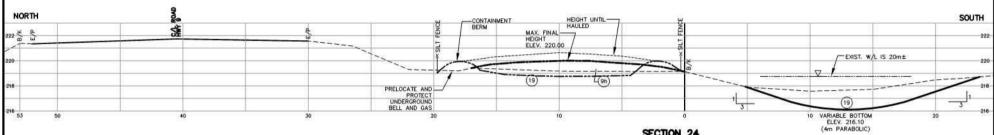


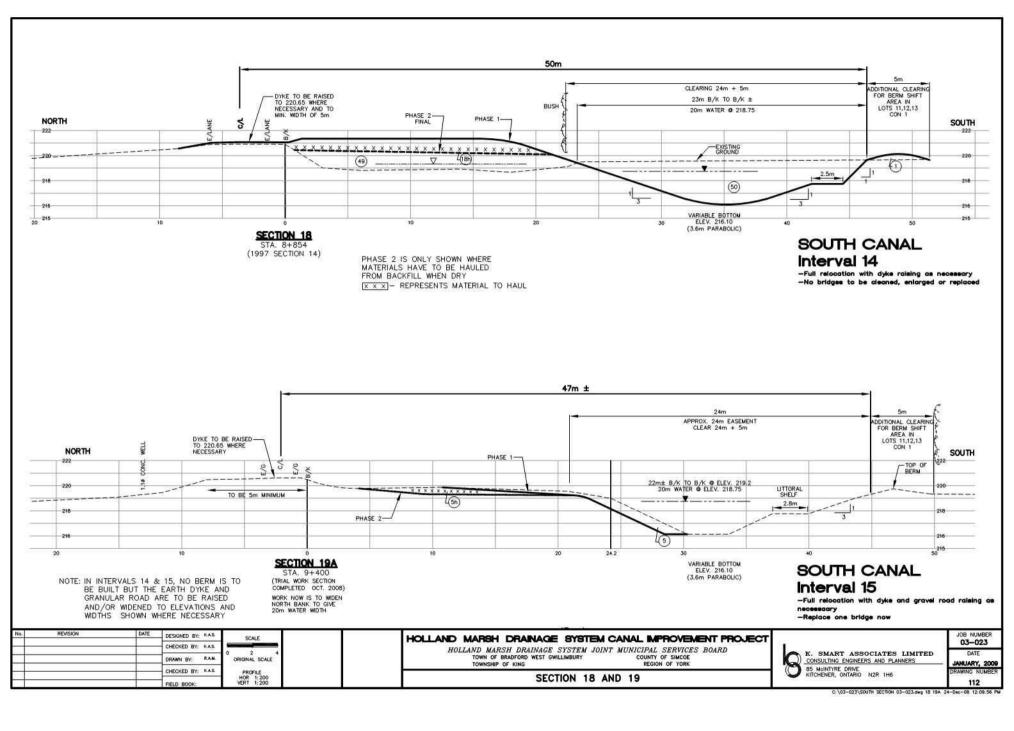

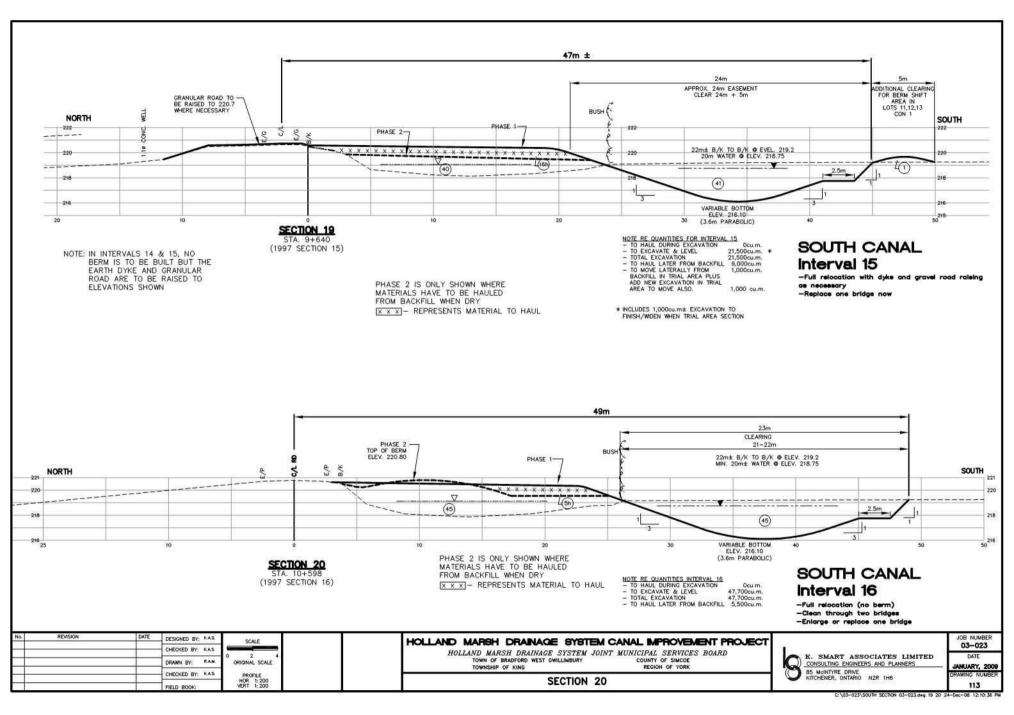

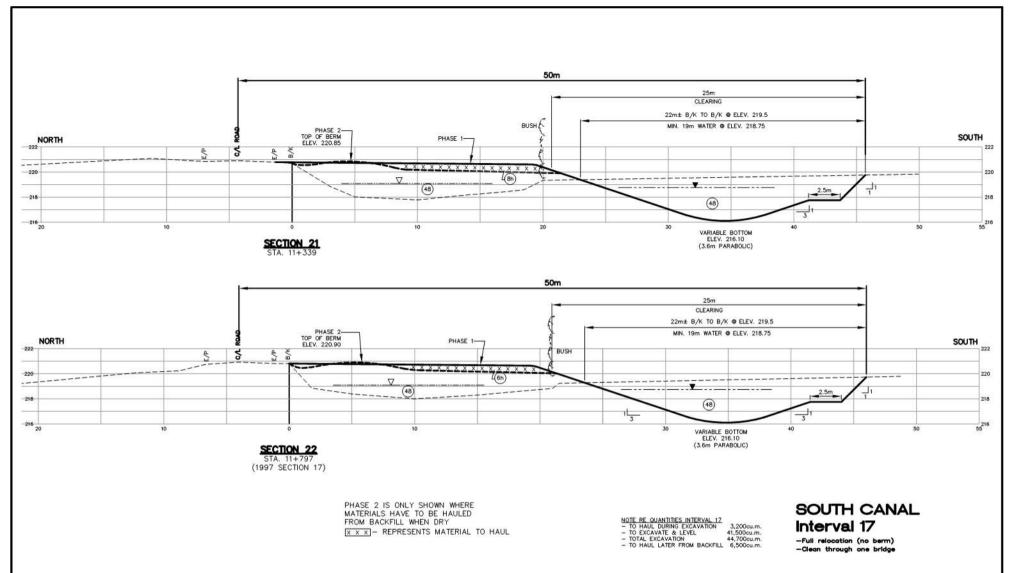PROFILE PRELD BOOK: VERT 1:200 PRELD BOOK: VE	No.	REVISION	DATE	DESIGNED BY: K.A.S. CHECKED BY: K.A.S. DRAWN BY: R.A.M.	SCALE 0 2 4 ORIGINAL SCALE		HOLLAND MARSH DRAINAGE SYSTEM CANAL IMPROVEMENT PROJECT HOLLAND MARSH DRAINAGE SYSTEM JOINT MUNICIPAL SERVICES BOARD TOWN OF BRAFFORD WEST GWILLIMBURY COUNTY OF SIMCOR TOWNSHIP OF KIND	K. SMART ASSOCIATES LIMITED CONSULTING ENGINEERS AND PLANNERS	JOB NUMBER 03-023 DATE JANUARY, 2009
	8 8			FIELD BOOK:	HOR 1: 200	PROFILE HOR 1:200 VERT 1:200	SECTIONS 21, 22	KITCHENER, ONTARIO N2R 1H6	DRAWING NUMBER



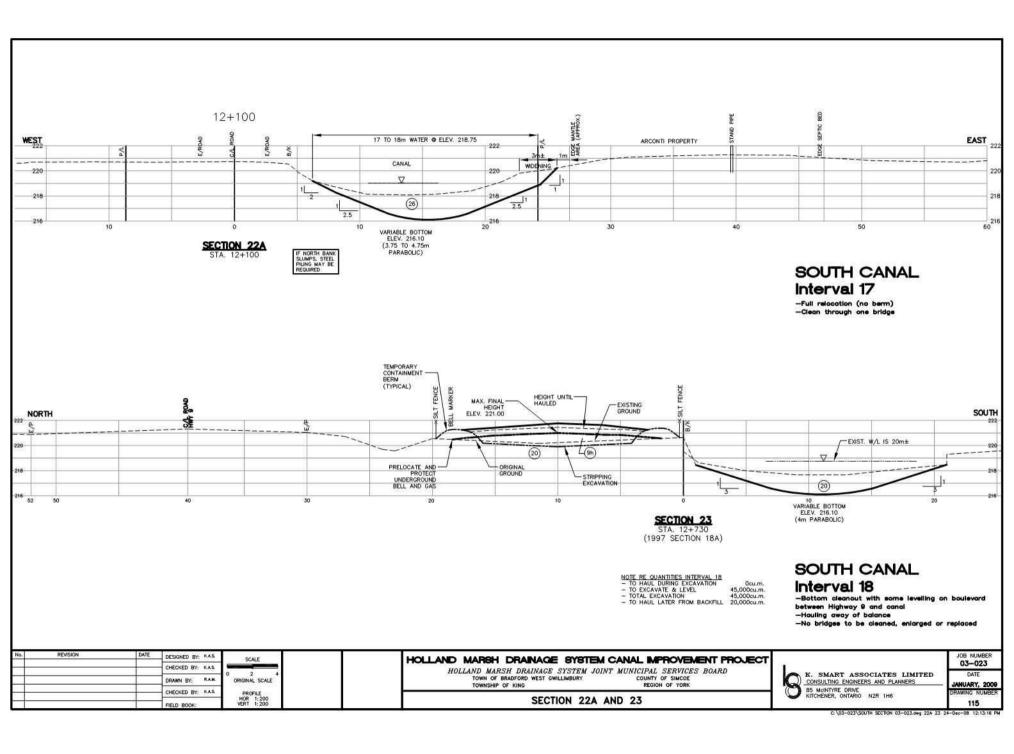


SECTION 24 STA. 13+550 (STA. 13+568 May 2008) (1997 SECTION 18)

SOUTH CANAL Interval 18

-Bottom cleanout with some levelling on boulevard between Highway 9 and canal -Hauling away of balance
-No bridges to be cleaned, enlarged or replaced

No. REVISION DATE DESIGNED BY: K.A.S. CALE CHECKED BY: K.A.S. CALE DRAWN BY: R.A.M. ORIGINAL SCALE	HOLLAND MARSH DRAINAGE SYSTEM CANAL IMPROVEMENT PROJECT HOLLAND MARSH DRAINAGE SYSTEM JOINT MUNICIPAL SERVICES BOARD TOWN OF BRAINFORD WEST GWILLIMBURY COUNTY OF SINCOE TOWNSHIP BOF KING REGION OF YORK	(/ B 85 McINTYRE DRIVE	JOB NUMBER 03-023 DATE JANUARY, 2009
CHECKED BY: KAS. PROFILE HOR 1: 200 FIELD BOOK: VERT 1: 200	SECTION 24	KITCHENER, ONTARIO N2R 1H6	DRAWING NUMBER 116

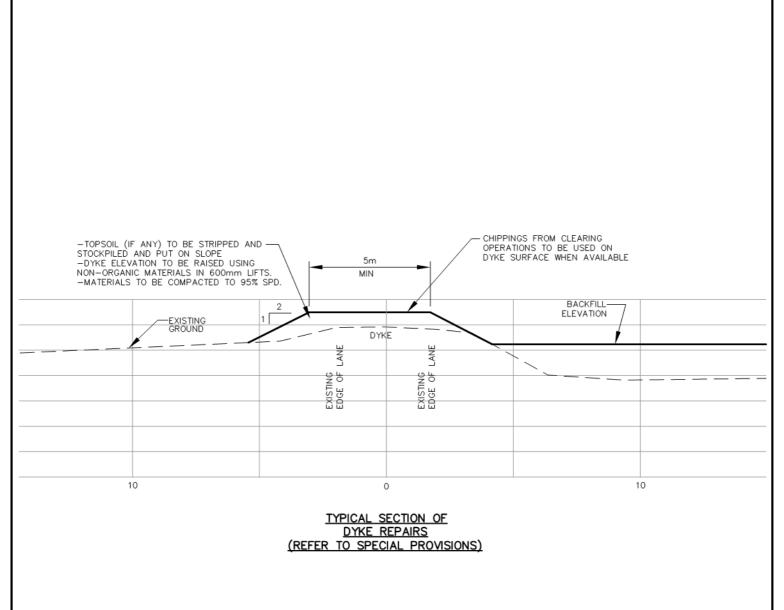

SCALE 1:150

1.5 3m

HOLLAND MARSH DRAINAGE SYSTEM CANAL IMPROVEMENT PROJECT

HOLLAND MARSH DRAINAGE SYSTEM JOINT MUNICIPAL SERVICES BOARD TOWN OF BRADFORD WEST GWILLIMBURY COUNTY OF SIMCOE TOWNSHIP OF KING REGION OF YORK

CROSS SECTION OF RAISED AND/OR WIDENED DYKE


JOB NUMBER 03-023

DATE


JANUARY, 2009

DRAWING NUMBER

117

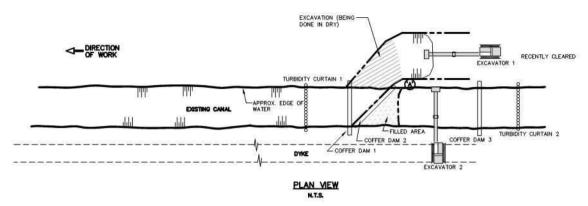

IF AT AN END OF SECTION WORK

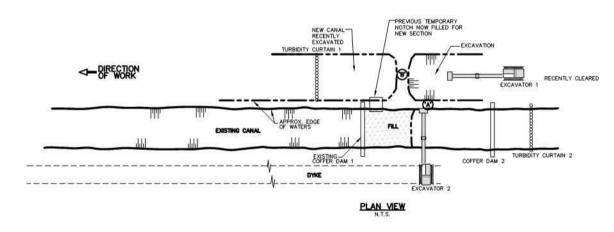

IF AT A MID SECTION WORK

SEQUENCE OF WORK

- 1) FILL NEW EXCAVATION WITH WATER BY PUMPS
- 2 DIG NOTCH AT 'A'
- (3) EXCAVATOR 1 OPENS COFFER DAM 3
- 4 EXCAVATOR 2 OPENS COFFER DAM 1
- (5) REMOVE TURBIDITY CURTAINS 1 AND 2

SEQUENCE OF WORK


- 1) FILL NEW EXCAVATION WITH WATER BY PUMPS
- (2) DIG NOTCH AT 'A'
- (3) EXCAVATOR 1 REMOVES COFFER DAM 2
- (4) EXCAVATOR 2 TRAVELS OVER COFFER DAM 1 AND OPENS AREA 'B'
- (5) REMOVE TURBIDITY CURTAINS 1 AND 2


PROVISION FOR FLOODING
IN RELOCATION WORK



DRAWING NUMBER

118

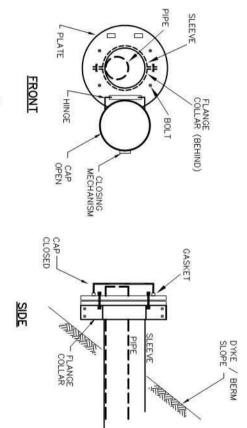

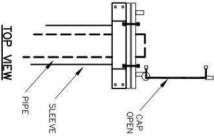

- 1/4" STEEL PLATE ATTACHED TO COLLAR
 FASTENED TO PLATE IS A CAP THAT IS FREE TO CLOSE
 AND COVER PIPE WHEN CLOSED.
 CLOSING MECHANISM ATTACHED TO CAP AND PLATE,
 TO SECURE IT ONCE CLOSED.
 RUBBER GASKET ATTACHED FOR TIGHT FIT.

WHERE PIPE REMAINS IN SLEEVE CAPPING PLATE DETAIL



CHECK VALVE DETAIL

HOLLAND MARSH DRAINAGE SYSTEM CANAL IMPROVEMENT PROJECT

HOLLAND MARSH DRAINAGE SYSTEM JOINT MUNICIPAL SERVICES BOARD TOWN OF BRADFORD WEST GWILLIMBURY COUNTY OF SIMCOE TOWNSHIP OF KING REGION OF YORK

CAPPING PLATE AND


CHECK VALVE DETAILS

03-023 DATE

JOB NUMBER

DRAWING NUMBER JANUARY, 2009

119

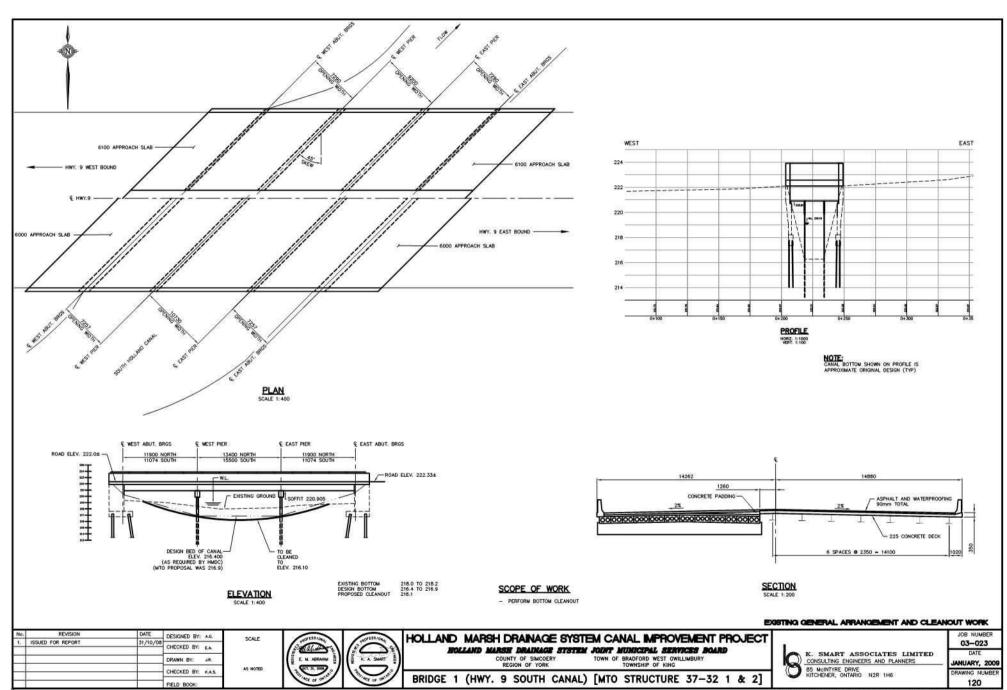



No.	REVISION	DATE	DESIGNED BY: A.G.	SCALE
_			CHECKED BY: EA.	1:750
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HOLLAND MARSH DRAINAGE SYSTEM CANAL IMPROVEMENT PROJECT ROLLAND MARSH DRAINAGE SYSTEM JOINT MUNICIPAL SERVICES BOARD


COUNTY OF SINCORRY TOWN OF BRABFORD WEST GWILLIBBURY TOWNSHIP OF KING

BRIDGE 1 (HWY. 9 SOUTH CANAL) [MTO STRUCTURE 37-32 1 & 2]



K. SMART ASSOCIATES LIMITED CONSULTING ENGINEERS AND PLANNERS 85 MENTYRE DRIVE KITCHERR, ONTARIO N2R 1H6

03-023

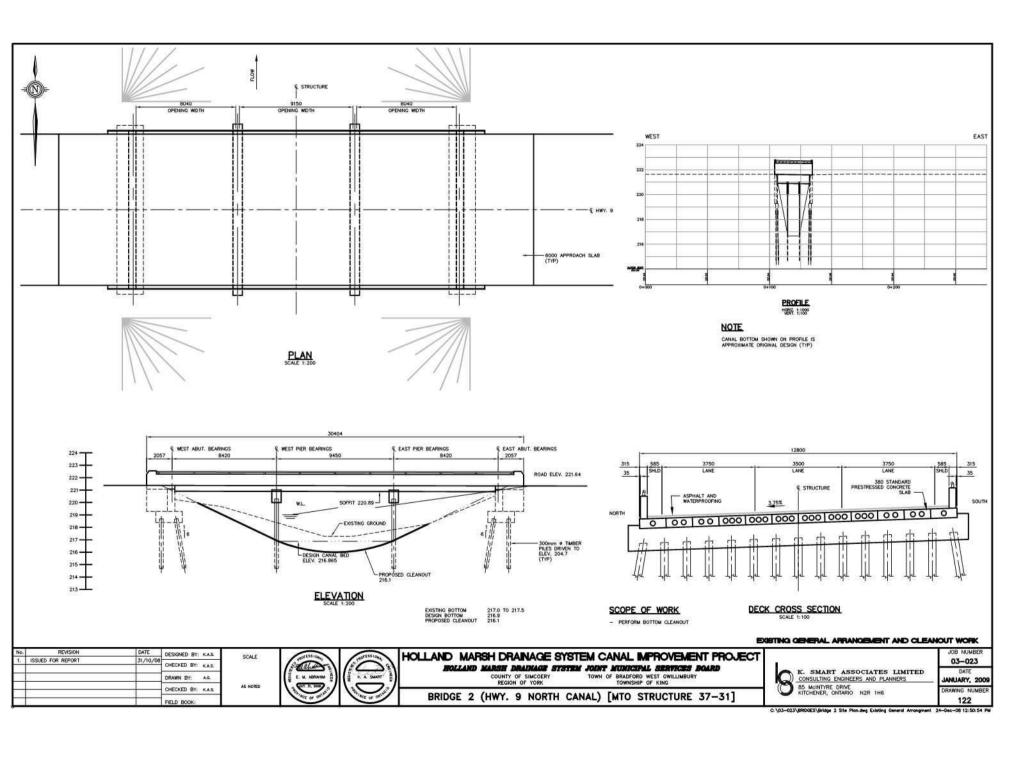




No.	REVISION	DATE	DESIGNED BY: A.G.	SCA
-			CHECKED BY: EA.	1:7
			DRAWN BY: D.C.P.	l
		- 4	CHECKED BY: EA.	band.
		- 4	DELD BOOK:	ı


HOLLAND MARSH DRAINAGE SYSTEM CANAL IMPROVEMENT PROJECT ROLLAND MARSH DRAINAGE SYSTEM JOINT MUNICIPAL SERVICES BOARD COUNTY OF SINCORRY TOWN OF BRABFORD WEST GWILLIBBURY TOWNSHIP OF KING


BRIDGE 2 (HWY. 9 SOUTH CANAL)

K. SMART ASSOCIATES LIMITED
CONSULTING ENGINEERS AND PLANNERS
85 MCINTYRE DRIVE
KITCHERE, ONTARIO N2R 1H6


03-023 ANUARY, 2009

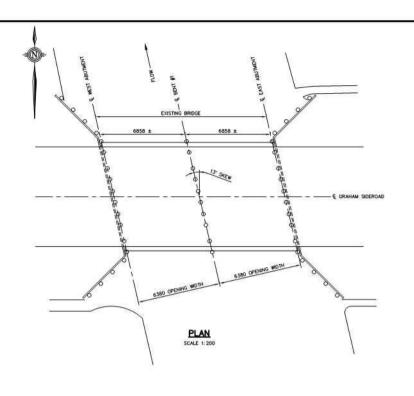

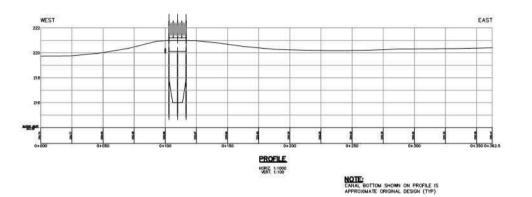

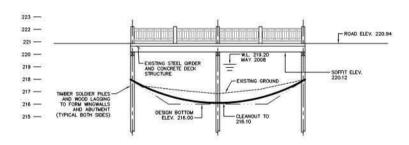

ELEVATION SCALE 1:200

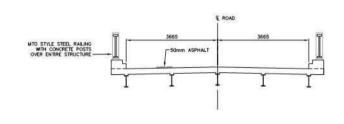


SCOPE OF WORK


- PERFORM BOTTOM CLEANOUT

EXISTING GENERAL APPRANCISHENT AND REQUIRED INITIAL WORK

DECK CROSS-SECTION
SCALE 1:100

No. REVISION DATE DESIGNED BY: A4. 1. ISSUED FOR REPORT 33/10/08 CHECKED BY: EA. DRAWN BY: A4.	SCALE CONTRACTOR E.	M. ABRAHM B	HOLLAND MARSH DRAINAGE SYSTEM CANAL IMPROVEMENT PROJECT HOLLAND MARSH DRAINAGE SYSTEM JOINT MUNICIPAL SERVICES BOARD COUNTY OF SINCOCERY TOWN OF BRAFORD WEST GWILLINBURY TOWNSHIP OF KING	K. SMART ASSOCIATES LIMITED	JOB NUMBER 03-023 DATE JANUARY, 2009
CHECKED BY: KAS. FIELD BOOK:	AS NOTED	The or of the second se	BRIDGE 3 (GRAHAM SIDEROAD SOUTH CANAL) [KING TWP. BRIDGE 00013]		DRAWING NUMBER

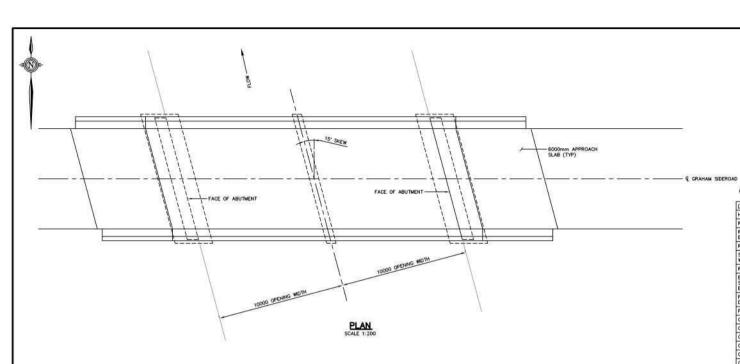

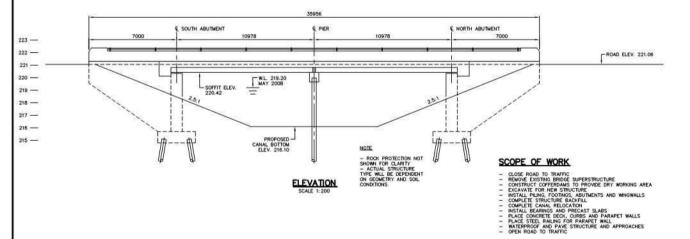


COST BREAKDOWN

ITEM	ESTIMATED QUANTITY	UNIT PRICE	TOTAL PRICE
HL4 ASHPALT*	254 TONNES	\$150	\$38,100
ROADWORK*	SEE NOTE 1	LUMP SUM	\$30,000
REMOVAL OF EXISTING STRUCTURE	N/A	LUMP SUM	\$25,000
ROCK PROTECTION	100 m^3	\$150	\$15,000
STEEL BEAM GUIDE RAILS WITH CHANNEL	60.96 m	\$150	\$9,144
RESTORATION	N/A	LUMP SUM	\$10,000
EARTH EXCAVATION FOR NEW STRUCTURE, DEWATERING AND EARTH BACKFILL	N/A	LUMP SUM	\$75,000
PILING MOBILIZATION AND DEMOBILIZATION	N/A	LUMP SUM	\$50,000
PILING - DRIVEN IN PLACE	250 m	\$100	\$25,000
CONCRETE IN FOOTING	60 m^3	\$750	\$45,000
CONCRETE IN ABUTMENTS	130 m^3	\$1000	\$130,000
CONCRETE IN PIER CAP	12 m^3	\$1000	\$12,000
CONCRETE IN DECK	51 m^3	\$1,200	\$61,200
CONCRETE IN CURBS	16 m^3	\$750	\$12,000
CONCRETE IN PARAPET WALL	14 m^3	\$750	\$10,500
REINFORCING STEEL BAR (UNCOATED & COATED)	20 TONNES	\$3,500	\$70,000
STEEL RAILING FOR BARRIER WALL	N/A	LUMP SUM	\$13,000
PRESTRESSED HOLLOW SLABS	183 m	\$1300	\$237,900
BRIDGE DECK WATERPROOFING	N/A	LUMP SUM	\$11,000
NATURAL RUBBER BEARINGS	N/A	LUMP SUM	\$4,000
CONTINGENCIES	N/A	LUMP SUM	\$85,000

. ASSUMING 200m TOTAL ROADWORK BEYOND BRIDGE


WITH ENGINEERING INCLUDED BUDGET \$1,200,000.00

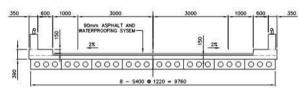

DECK CROSS-SECTION SCALE 1:100

CONCEPTUAL GENERAL ARRANGEMENT FOR STRUCTURE REPLACEMENT

No.	REVISION DATE SISSUED FOR REPORT 31/10/	DESIGNED BY: AG. OB CHECKED BY: EA DRAWN BY: JR. CHECKED BY: K.A.S. FIELD BOOK:	SCALE AS HOTED	E M. ASPANIAN ES	K. A. SMART OF ORTHO	HOLLAND MARSH DRAINAGE SYSTEM CANAL IMPROVEMENT PROJECT HOLLAND MARSH DRAINAGE SYSTEM JOINT MUNICIPAL SERVICES BOARD COUNTY OF SIMOCERY TOWN OF BRADFORD WEST CHILLIMBURY REGION OF YORK TOWNSHIP OF KING BRIDGE 3 (GRAHAM SIDEROAD SOUTH CANAL) [KING TWP. BRIDGE 00013]	K. SMART ASSOCIATES LIMITED CONSULTING ENGINEERS AND PLANNERS 85 MCHRYCE DRIVE KITCHENER, ONTARIO N2R 1H6	JOB NUMBER 03-023 DATE JANUARY, 2009 DRAWING NUMBER 125
		FIELD BOOK:					C:\03-023\BRIDGES\Bridge 3 Site Plan.dwg SCHEME 3	

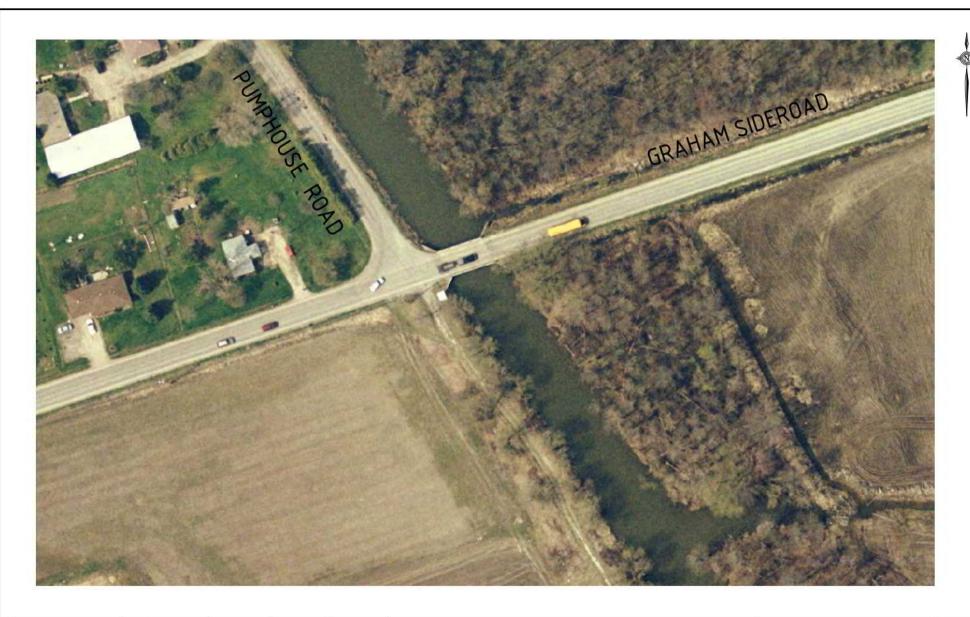

No.	REVISION	DATE	DESIGNED BY: A.G.	SCALE
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			DRAWN BY: D.C.P.	3.75m 0 7.5m
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HOLLAND MARSH DRAINAGE SYSTEM CANAL IMPROVEMENT PROJECT EOLIAND MARSH DRAINAGE SYSTEM JOINT MUNICIPAL SERVICES BOARD


COUNTY OF SINCOCRY TOWN OF BRADFORD WEST GWILLINBURY
REGION OF YORK TOWNSHIP OF KING

BRIDGE 3 (GRAHAM SIDEROAD SOUTH CANAL) [KING TWP. BRIDGE 00013]



K. SMART ASSOCIATES LIMITED
CONSULTING ENGINEERS AND PLANNERS
85 MIGHTYRE DRIVE
KITCHERE, ONTARIO N2R 1H6

03-023 JOB NUMBER ANUARY, 2009

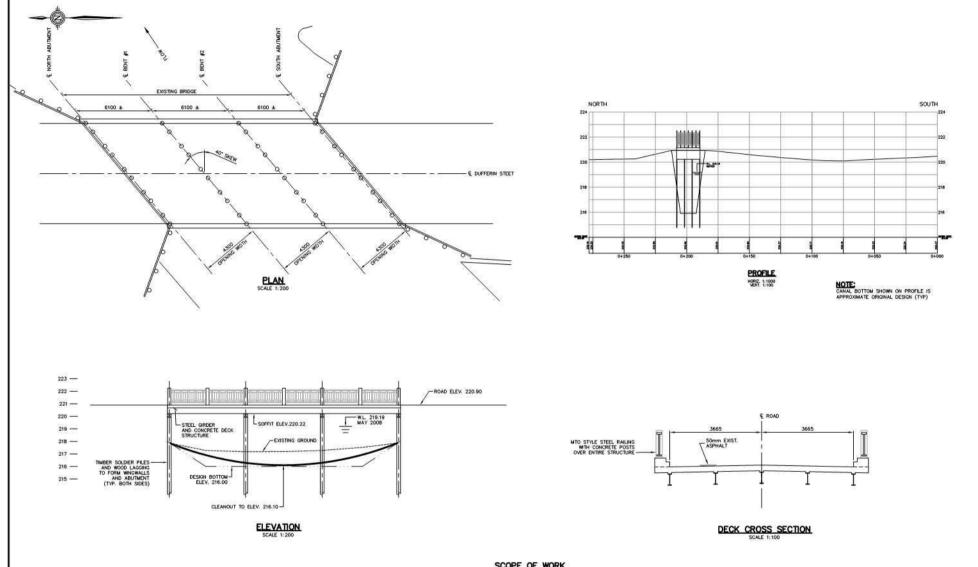



SCOPE OF WORK

- PERFORM BOTTOM CLEANOUT

EXISTING GENERAL APPRANCISATION AND REQUIRED INITIAL WORK

No.	DATE ISSUED FOR REPORT 31/10/08	DESIGNED BY: A.G. CHECKED BY: E.A. DRAWN BY: JR. CHECKED BY: K.A.S. FIELD BOOK:	SCALE AS NOTED	E. M. ASSAHIN ESTATE OF STATE	TO TESTION CONTROL OF THE PROPERTY OF THE PROP	HOLLAND MARSH DRAINAGE SYSTEM CANAL IMPROVEMENT PROJECT ROLLAND MARSH DRAINAGE SYSTEM JOINT MUNICIPAL SERVICES BOARD COUNTY OF SINCOERY TOWN OF BRADFORD WEST GWILLINBURY REGION OF YORK TOWNSHIP OF KING BRIDGE 4 (DUFFERIN ST. SOUTH CANAL) [KING TWP. BRIDGE 00012]	K. SMART ASSOCIATES LIMITED CONSULTING ENGINEERS AND PLANNERS 85 MGNTYRE DRIVE KITCHENER, ONTARIO N2R 1H6	JOB NUMBER 03-023 DATE JANUARY, 2009 DRAWING NUMBER 127	
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No.	REVISION	DATE	DESIGNED BY: A.G.	SCALE	
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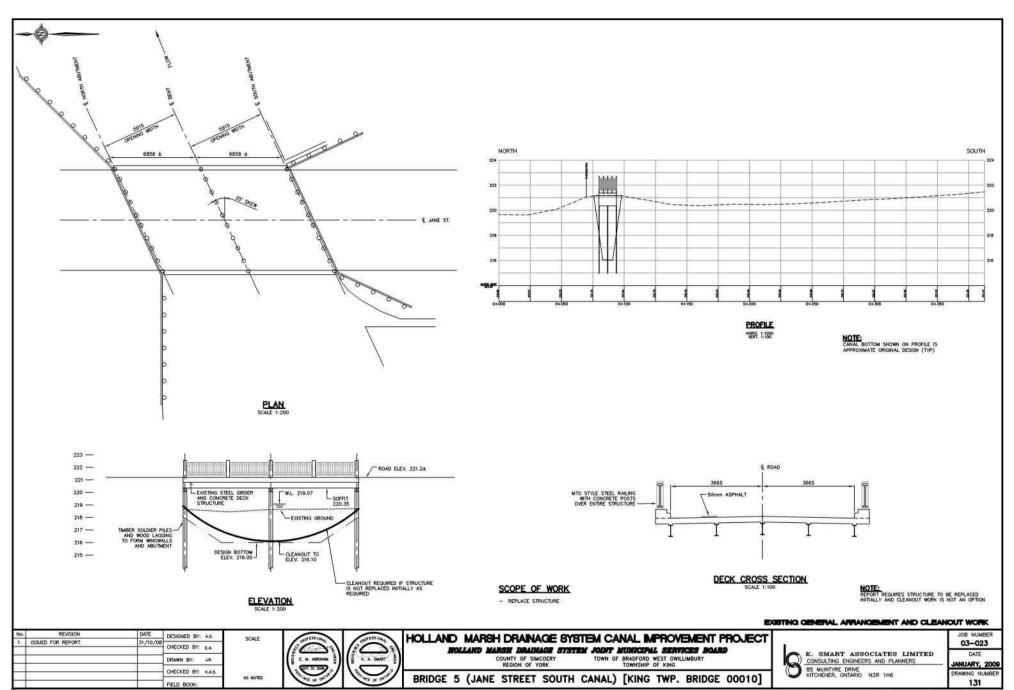
HOLLAND MARSH DRAINAGE SYSTEM CANAL IMPROVEMENT PROJECT ROLLAND MARSH DRAINAGE SYSTEM JOINT MUNICIPAL SERVICES BOARD

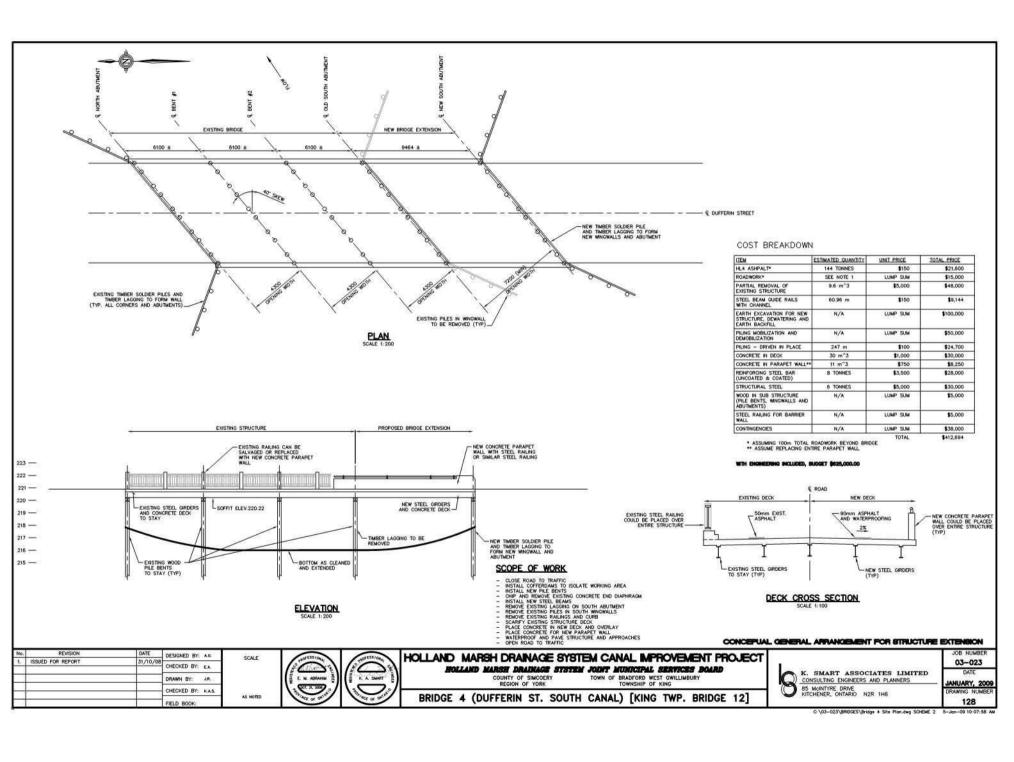
COUNTY OF SINCORRY TOWN OF BRABFORD WEST GWILLIBBURY TOWNSHIP OF KING

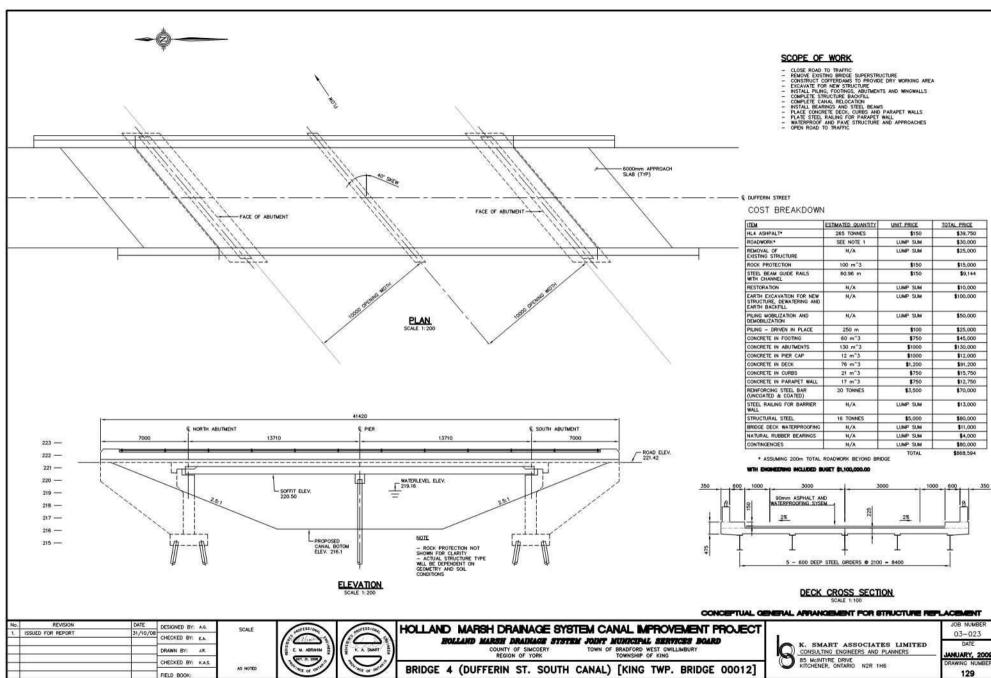BRIDGE 4 (DUFFERIN ST. SOUTH CANAL) [KING TWP. BRIDGE 00012]



JOB NUMBER
03-023
DATE
JANUARY, 2009
DRAWING NUMBER
130




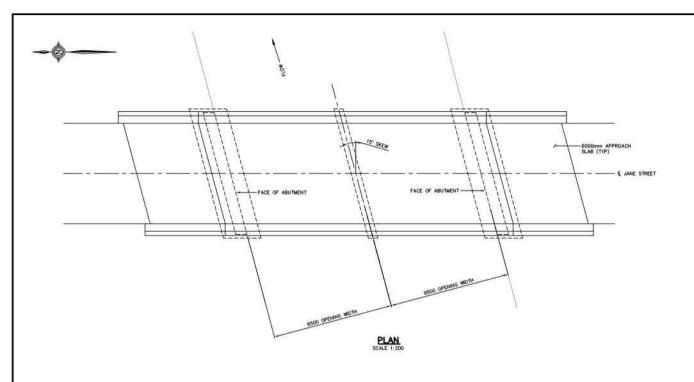




* ASSUMING 200m TOTAL ROADWORK BEYOND BRIDGE

WITH ENGINEERING INCLUDED BUDGET \$1,200,000.00

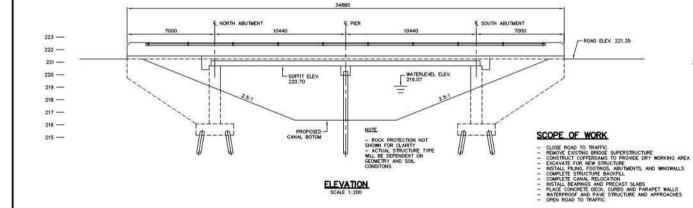

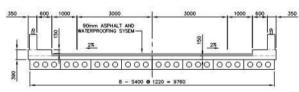

DECK CROSS SECTION SCALE 1:100


CONCEPTUAL GENERAL AFRANCEMENT FOR STRUCTURE REPLACEMENT

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No.	REVISION	DATE	DESIGNED BY: A.G.	SCALE	HOLLAND MARSH DRAINAGE SYSTEM CANAL IMPROVEMENT PROJECT	
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			DRAWN BY: D.C.P.	3.75m 0 7.5m	COUNTY OF SIMCOERY TOWN OF BRADFORD WEST GWILLINBURY REGION OF YORK TOWNSHIP OF KING	CONSULTING ENGINEERS AND PLANNERS
		-	CHECKED BY: EA.	375m 0 75m		85 McINTYRE DRIVE KITCHENER, ONTARIO N2R 1H6
	,	Ť	FIELD BOOK:		BRIDGE 5 (JANE STREET SOUTH CANAL) [KING TWP. BRIDGE 00010]	- N
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No.	REVISION	DATE	DESIGNED BY: A.G.	
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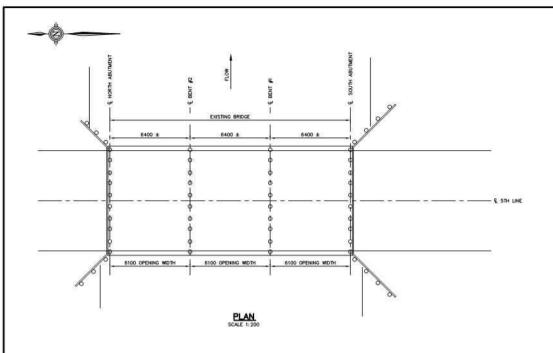
SCALE 1:750 HOLLAND MARSH DRAINAGE SYSTEM CANAL IMPROVEMENT PROJECT ROLLAND MARSH DRAINAGE SYSTEM JOINT MUNICIPAL SERVICES BOARD


COUNTY OF SINCORRY TOWN OF BRABFORD WEST HULLIBURY TOWNSHIP OF KING

BRIDGE 6 (KEELE STREET SOUTH CANAL) [KING TWP. BRIDGE 00011]

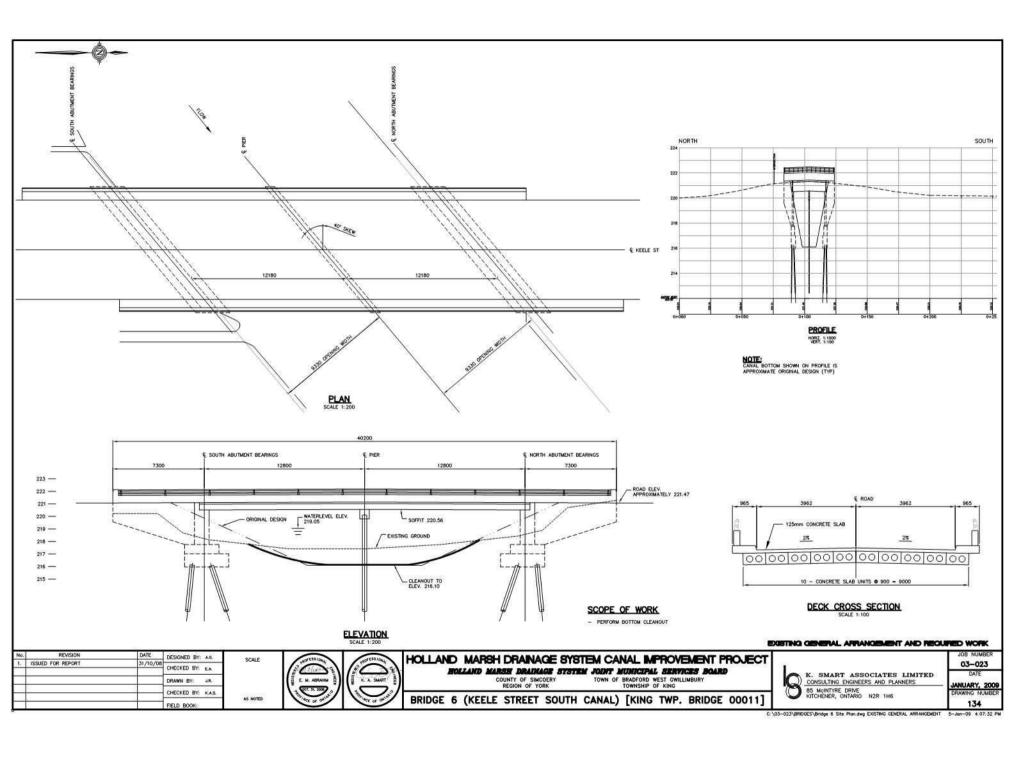


JOB NUMBER 03-023 ANUARY, 200




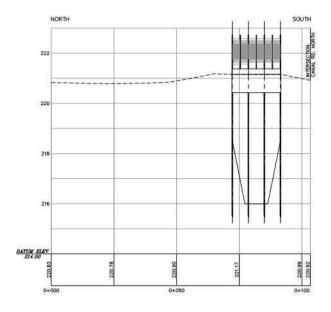

PROFILE

NOTE: CANAL BOTTOM SHOWN ON PROFILE IS APPROXIMATE ORIGINAL DESIGN (TYP)

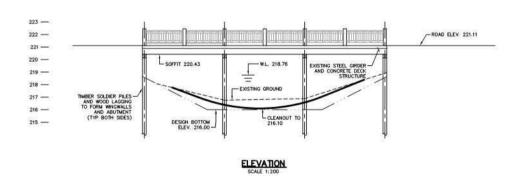

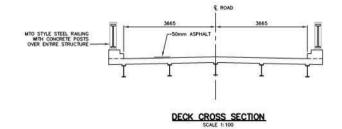



SCOPE OF WORK

- PERFORM BOTTOM CLEANOUT

XISTING GENERAL APPRANCISMENT AND REQUIRED INITIAL WORK

CHECKED BY: KAS.	COUNTY OF SIMCORY TOWN OF BRADFORD WEST GWILLIMBURY REGION OF YORK K. SMART ASSOCIATES LIMITED CONSULTING ENGINEERS AND PLANNERS JA TOWNSHIP OF KING TOWNSHIP	DATE JANUARY, 2005 DRAWING NUMBER
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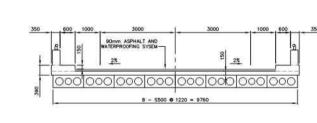


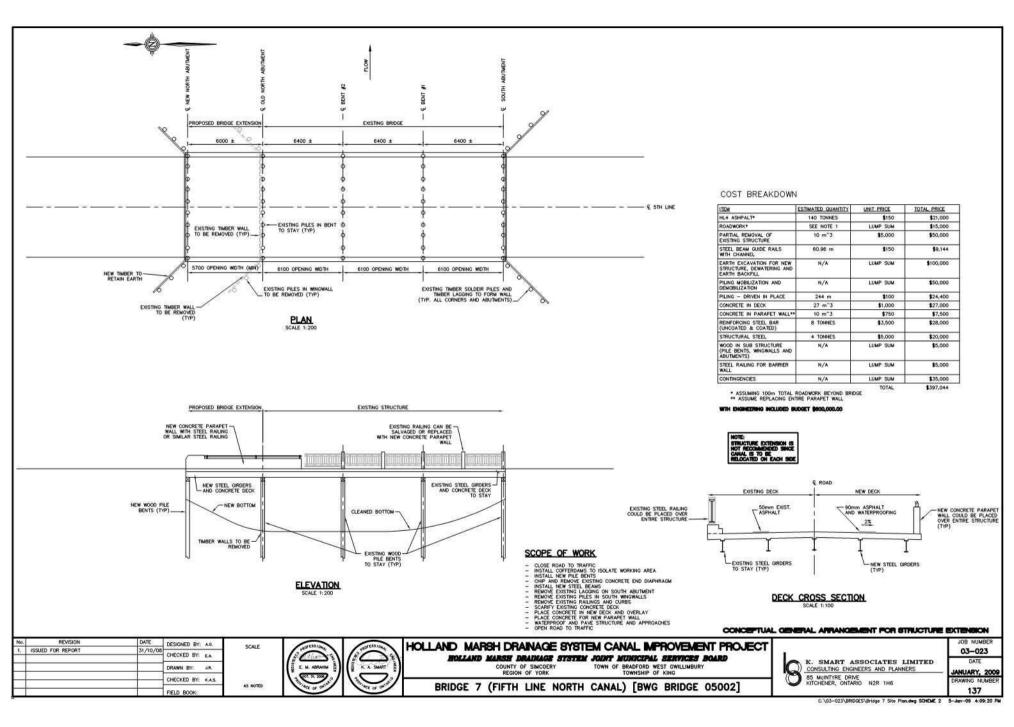COST BREAKDOWN

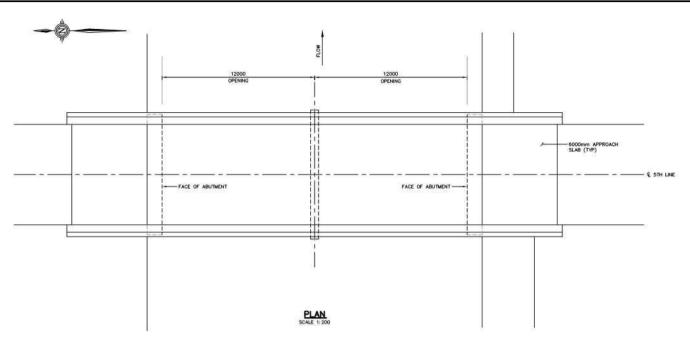ITEM	ESTIMATED QUANTITY	UNIT PRICE	TOTAL PRICE
HL4 ASHPALT*	261 TONNES	\$150	\$39,150
ROADWORK*	SEE NOTE 1	LUMP SUM	\$35,000
REMOVAL OF EXISTING STRUCTURE	N/A	LUMP SUM	\$25,000
ROCK PROTECTION	100 m^3	\$150	\$15,000
STEEL BEAM GUIDE RAILS WITH CHANNEL	60.96 m	\$150	\$9,144
RESTORATION	N/A	LUMP SUM	\$10,000
EARTH EXCAVATION FOR NEW STRUCTURE, DEWATERING AND EARTH BACKFILL	N/A	LUMP SUM	\$75,000
PILING MOBILIZATION AND DEMOBILIZATION	N/A	LUMP SUM	\$30,000
PILING - HOLLOW TUBE	153 m	\$100	\$15,300
PILING - HP 310 x 110	220 m	\$350	\$77,000
CONCRETE IN ABUTMENTS	130 m^3	\$1,000	\$130,000
CONCRETE IN PIER CAP	12 m^3	\$1,000	\$12,000
CONCRETE IN DECK	40 m^3	\$1,000	\$40,000
CONCRETE IN CURBS	19 m ² 3	\$750	\$14,250
CONCRETE IN PARAPET WALL	15 m^3	\$750	\$11,250
REINFORCING STEEL BAR (UNCOATED & COATED)	20 TONNES	\$3,500	\$70,000
STEEL RAILING FOR BARRIER WALL	N/A	LUMP SUM	\$13,000
PRESTRESSED HOLLOW SLABS	205 m	\$1,700	\$348,500
BRIDGE DECK WATERPROOFING	N/A	LUMP SUM	\$11,000
NATURAL RUBBER BEARINGS	N/A	LUMP SUM	\$4,000
CONTINGENCIES	N/A	LUMP SUM	\$90,000

* ASSUMING 200m TOTAL ROADWORK BEYOND BRIDGE

WITH ENGNEEPING INCLUDED BUDGET \$1,300,000.00



DECK CROSS SECTION
SCALE 1:100

CONCEPTUAL GENERAL AFRANCEMENT FOR STRUCTURE REPLACEMENT

223 — 222 —	6000 E NORTH ABUTMEN	12775	PIER 12775	SOUTH ABUTMENT 6000	ROAD ELEV,
221 — 220 — 219 — 218 — 217 — 216 — 215 —	25	PROPOSED CANAL BOTTOM ELEV. 216.1	NOTE: - ROCK PROTECTION NOT SHOWN FOR CLARITY - ACTUAL STRUCTURE TYPE NO CONCINCION CONDITIONS	SCOPE OF W	350 g
		ELEVA SCALE 1		CONSTRUCT CORF EXCAVATE FOR N INSTALL PILING. COMPLETE STRUC COMPLETE CANALA INSTALL BEARING. PLACE CONCRETE PLACE STEEL RAI	BRIDGE SUPERSTRUCTURE FROMUS TO PROVIDE DRY WORKING AREA W STRUCTURE BUTTENTS, WINGWALLS AND PIERS BUTTENTS, WINGWALLS AND PIERS BUTTENTS, WINGWALLS AND PIERS RELOCATION AND PRECAST SLABS DECK, CURBS AND PARAPET WALLS ING FOR PARAPET WALL PAYE STRUCTURE AND APPROACHES

37550

SCALE

AS NOTED

DATE DESIGNED BY: A.G.

CHECKED BY: EA

DRAWN BY: JR.

CHECKED BY: K.A.S.

31/10/08

1. ISSUED FOR REPORT

K A SMART E. N. ABRAHIN

HOLLAND MARSH DRAINAGE SYSTEM CANAL IMPROVEMENT PROJECT HOLLAND MARSH DRAINAGE SYSTEM JOINT MUNICIPAL SERVICES BOARD

TOWN OF BRADFORD WEST GWILLIMBURY TOWNSHIP OF KING COUNTY OF SIMCOERY REGION OF YORK

BRIDGE 7 (FIFTH LINE NORTH CANAL) [BWG BRIDGE 05002]

K. SMART ASSOCIATES LIMITED
CONSULTING ENGINEERS AND PLANNERS
85 MCINTYRE DRIVE
KICHERER PURPERS 85 McINTYRE DRIVE KITCHENER, ONTARIO N2R 1H6

03-023 JANUARY, 2009 DRAWING NUMBER

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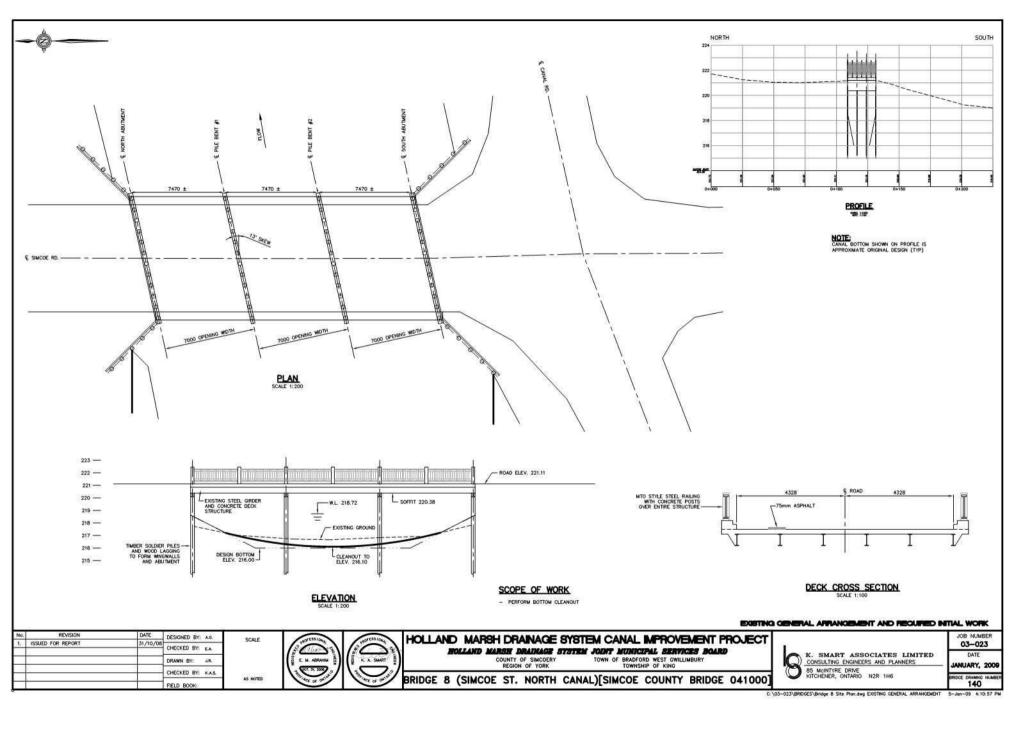
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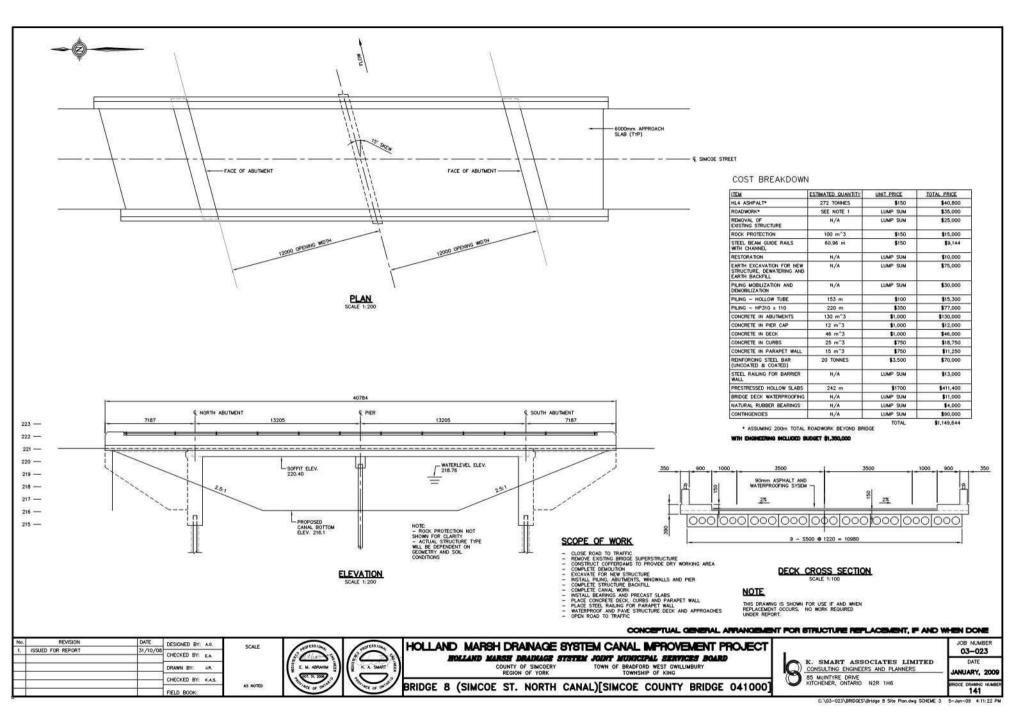
HOLLAND MARSH DRAINAGE SYSTEM CANAL MPROVEMENT PROJECT ROLLAND MARSH DRAINAGE SYSTEM JOINT MUNICIPAL SERVICES BOARD COUNTY OF SINCOCRY TOWN OF BRADFORD WEST GWILLINBURY REGION OF YORK

BRIDGE 7 (FIFTH LINE NORTH CANAL) [BWG TWP. BRIDGE 05002]

0	K. SMART ASSOCIATES LIMITED CONSULTING ENGINEERS AND PLANNERS
O	85 McINTYRE DRIVE KITCHENER, ONTARIO N2R 1H6

JOB NUMBER
03-023
DATE
JANUARY, 2009
DRAWING NUMBER








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HOLLAND MARSH DRAINAGE SYSTEM CANAL MPROVEMENT PROJECT ROLLAND MARSH DRAINAGE SYSTEM JOINT MUNICIPAL SERVICES BOARD
COUNTY OF SINCOCRY TOWN OF BRADFORD WEST GWILLINBURY TOWNSHIP OF KING


BRIDGE 8 (SIMCOE ST. NORTH CANAL) [SIMCOE COUNTY BRIDGE 041000]


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	CONSULTING ENGINEERS AND PLANNERS

JOB NUMBER
03-023
DATE
JANUARY, 2009
DRAWING NUMBER

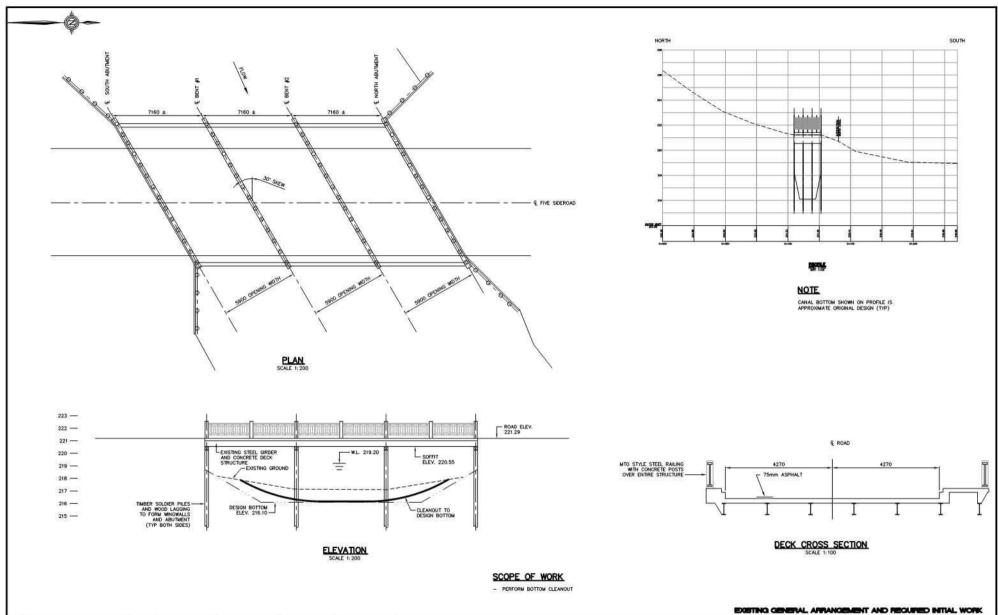

No.	REVISION DA ISSUED FOR REPORT 31,	TE DESIGNED E /10/08 CHECKED B DRAWN BY: CHECKED B	3Y: EA JR. 3Y: KAS.	SCALE AS NOTED	E M. ABRAHIM ES	K. A. SMART	HOLLAND MARSH DRAINAGE SYSTEM CANAL IMPROVEMENT PROJECT INCLUDING MARSH DRAINAGE SYSTEM JOINT MUNICIPAL SERVICES BOARD COUNTY OF SINCERY TOWNS OF SINALPOR WEST CONLLINEURY TOWNSHIP OF KIND OF KIND BRIDGE 9 (FIVE SIDEROAD NORTH CANAL) [BWG BRIDGE 02001]	K. SMART ASSOCIATES LIMITED CONSULTING ENGINEERS AND PLANNERS S MUNITURE ORIVE KITCHENER, ONTARIO N.ZR. 1H6	JOB NUMBER 03-023 DATE JANUARY, 2009 DRAWING NUMBER 143	
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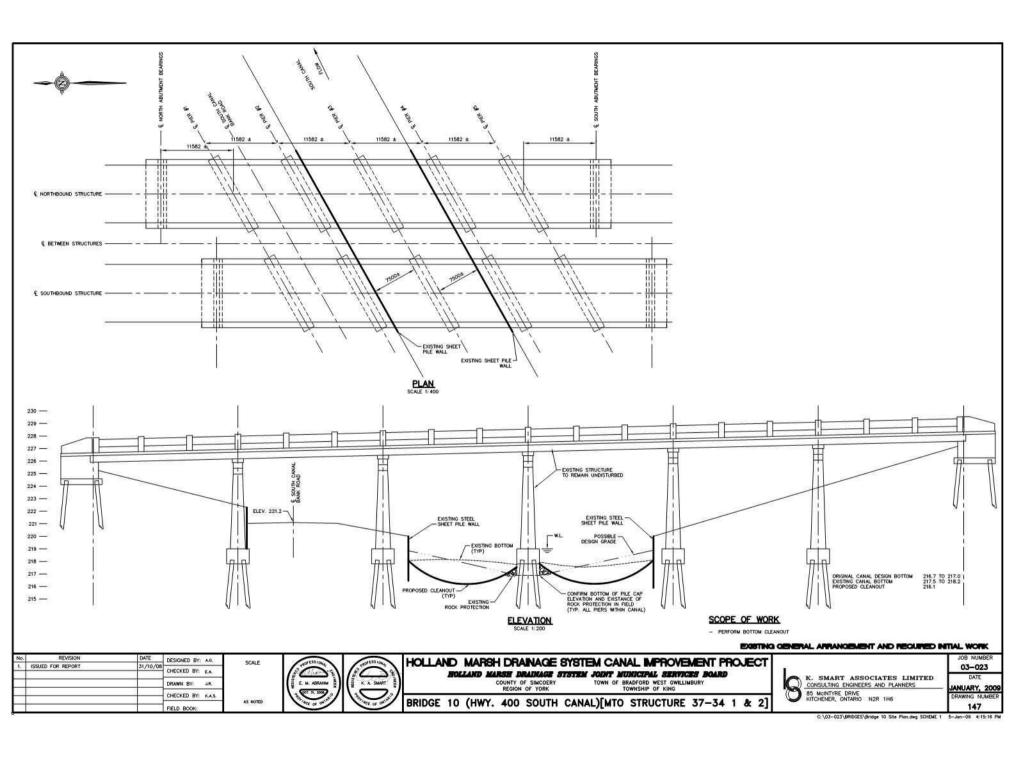
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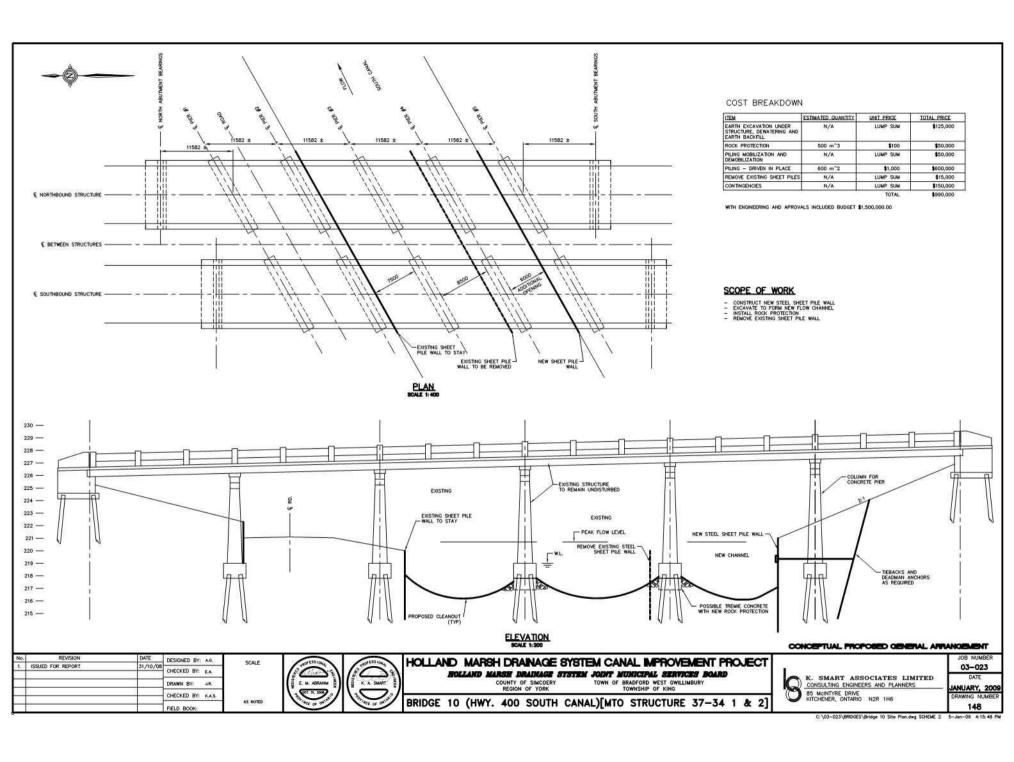
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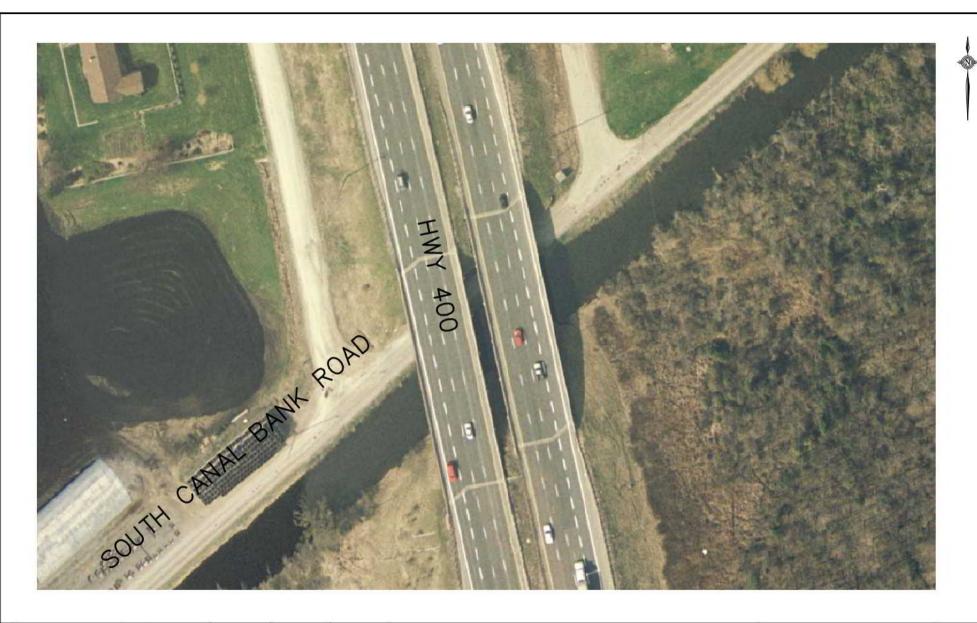
BRIDGE 9 (FIVE SIDEROAD NORTH CANAL) [BWG BRIDGE 02001]

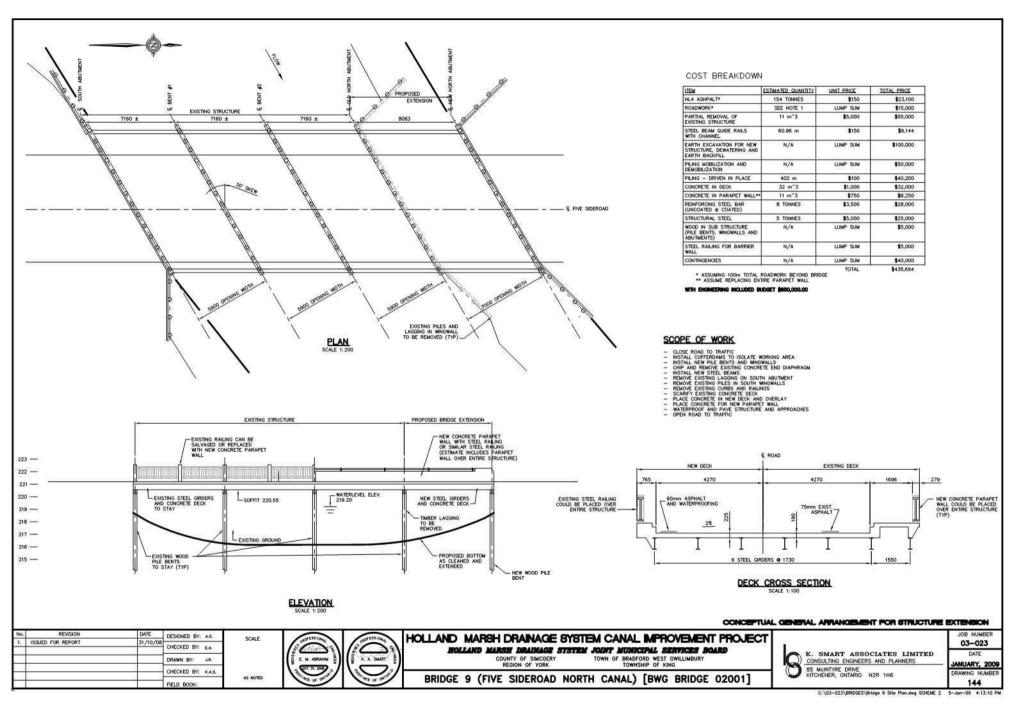K. SMART ASSOCIATES LIMITE
CONSULTING ENGINEERS AND PLANNERS
 85 McINTYRE DRIVE KITCHENER, ONTARIO N2R 1H6

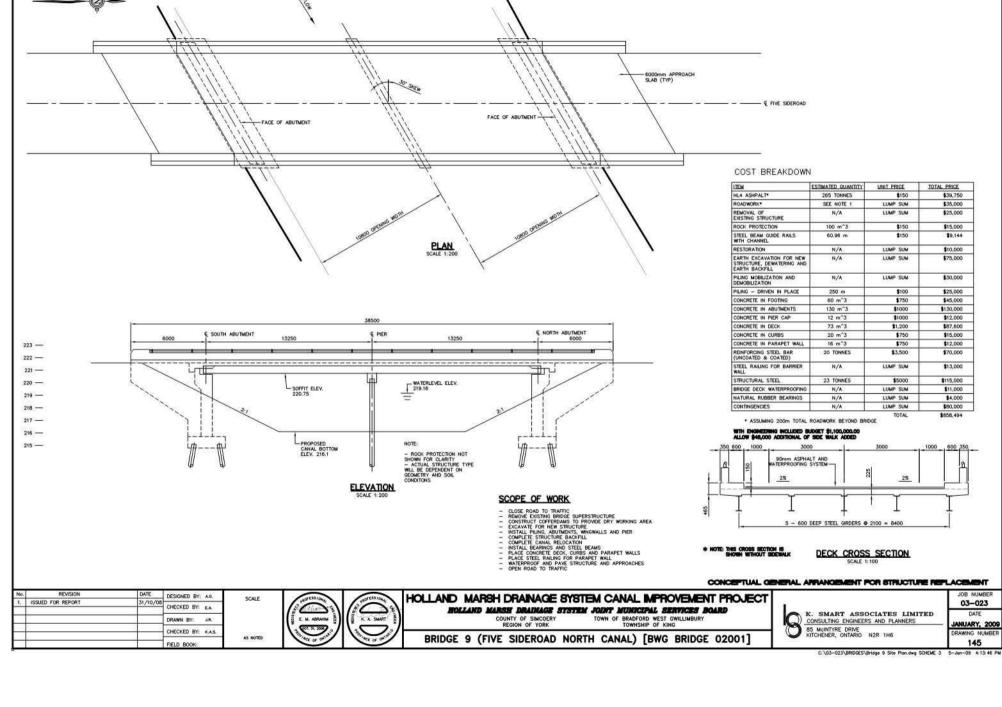JOB NUMBER
03-023
DATE
JANUARY, 2006
DRAWING NUMBER







No.	REVISION	DATE	DESIGNED BY: A.G.
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			DRAWN BY: D.C.P.
			CHECKED BY: EA.
-			DELD BOOK


SCALE 1:750 HOLLAND MARSH DRAINAGE SYSTEM CANAL IMPROVEMENT PROJECT EOLIAND MARSE DRAINAGE SYSTEM JOINT MUNICIPAL SERVICES BOARD
COUNTY OF SINCORRY
REGION OF YORK
TOWNSHIP OF KING


BRIDGE 10 (HWY 400 SOUTH CANAL)[MTO STRUCTURE 37-34 1 & 2]



K. SMART ASSOCIATES LIMITED
CONSULTING ENGINEERS AND PLANNERS
85 McINTYRE DRIVE
KICHENER, ONTARIO N2R 1H6

03-023 ANUARY, 2009

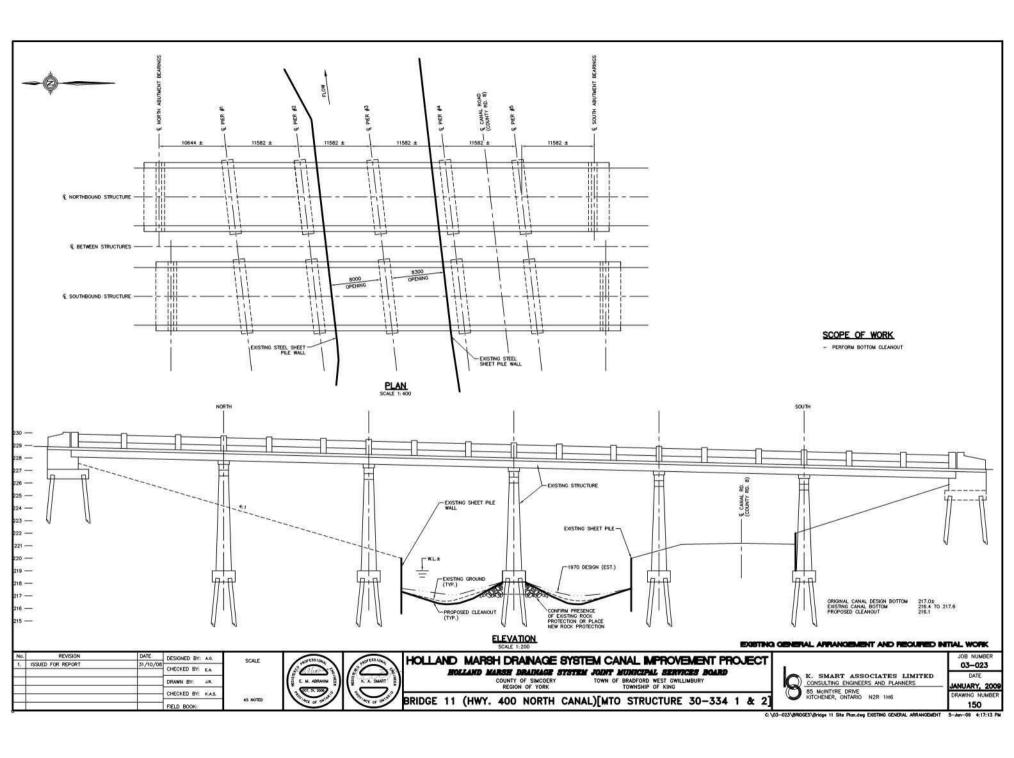

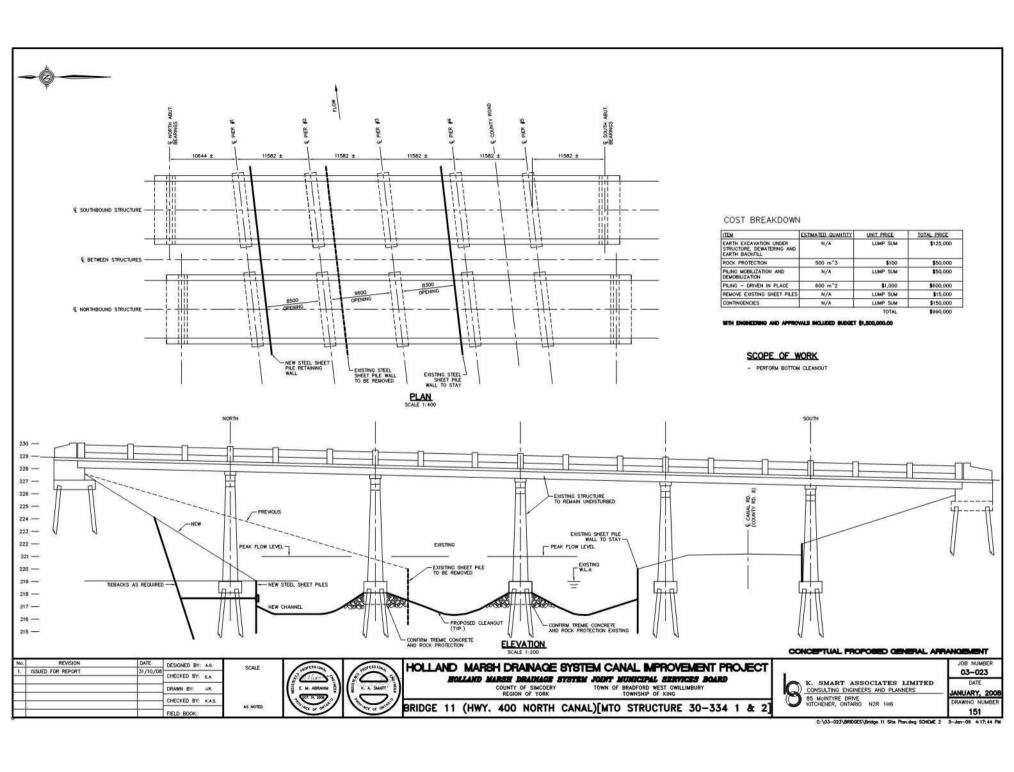



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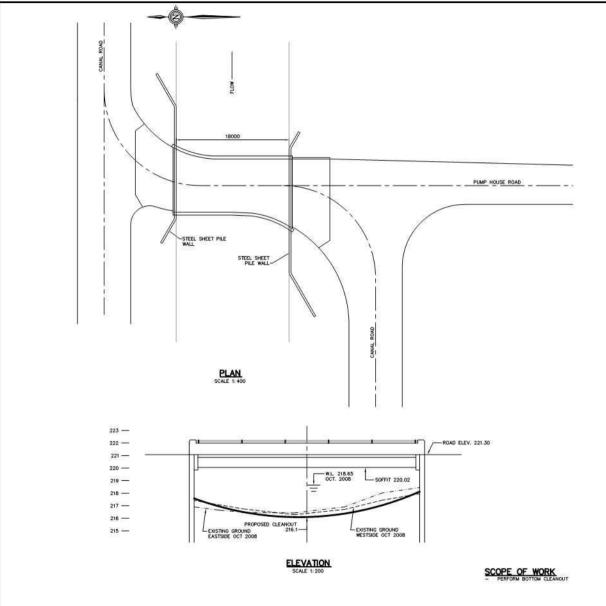
HOLLAND MARSH DRAINAGE SYSTEM CANAL IMPROVEMENT PROJECT HOLLAND MARSH DRAINAGE SYSTEM JOINT MUNICIPAL SERVICES BOARD COUNTY OF SINCOERY TOWN OF BRAFORD WEST HOLLANDURY TOWNSHE OF KING


BRIDGE 11 (HWY. 400 NORTH CANAL)[MTO STRUCTURE 30-334 1 & 2]




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03-023

DATE
JANUARY, 2009
BIODGE DRAWING NUMBER
152



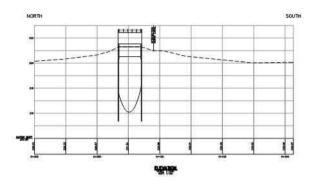

NOTE CANAL BOTTOM SHOWN ON PROFILE IS APPROXIMATE ORIGINAL DESIGN (TYP)

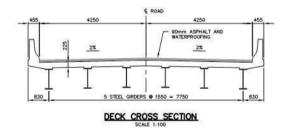

SIMCOE COUNTY STRUCTURE 008134

BRIDGE 12 (PUMPHOUSE RD. NORTH CANAL) [SIMCOE BRIDGE 008134]	L 530	-	2		EASING	A CENERAL APPARCEMENT AND RECURSED IN	
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No.	REVISION	DATE	DESIGNED BY: A.G.	SCALE	
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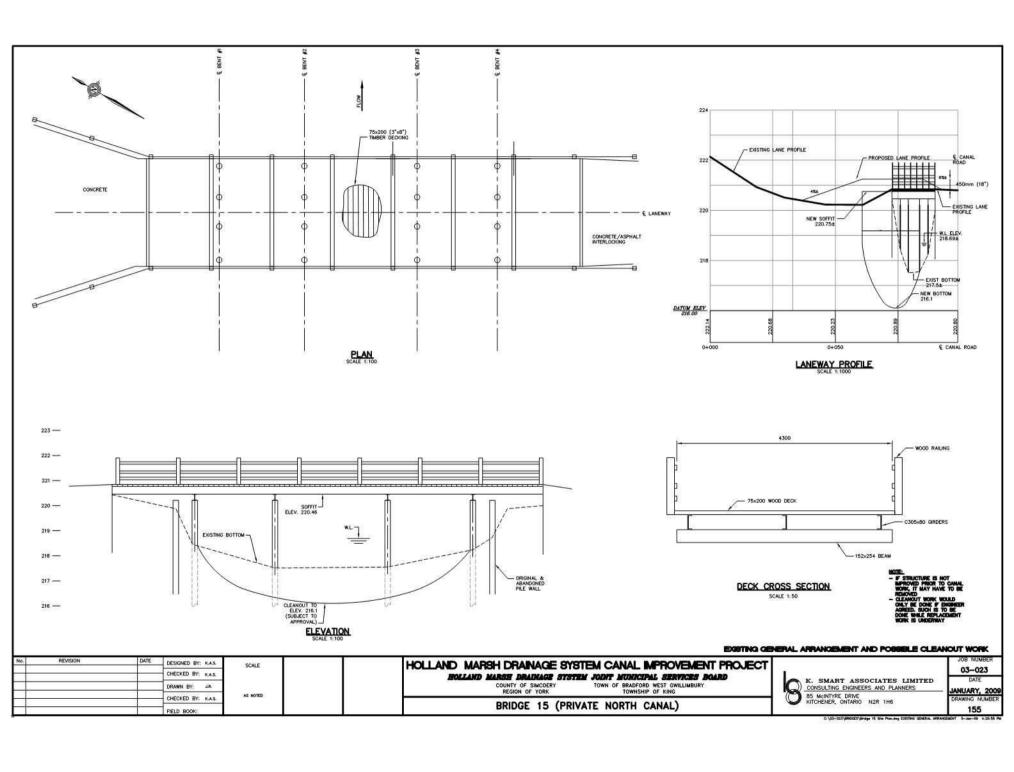
HOLLAND MARSH DRAINAGE SYSTEM CANAL IMPROVEMENT PROJECT HOLLAND MARSH DRAINAGE SYSTEM JOINT MUNICIPAL SERVICES BOARD


COUNTY OF SINCORRY TOWN OF BRAFFORD WEST GWILLINBURY TOWNSHIP OF KING

BRIDGE 12 (PUMPHOUSE RD. NORTH CANAL) [SIMCOE BRIDGE 008134]



JOB NUMBER
03-023
DATE
JANUARY, 2009
BRIDGE DRAWING NUMBER
154



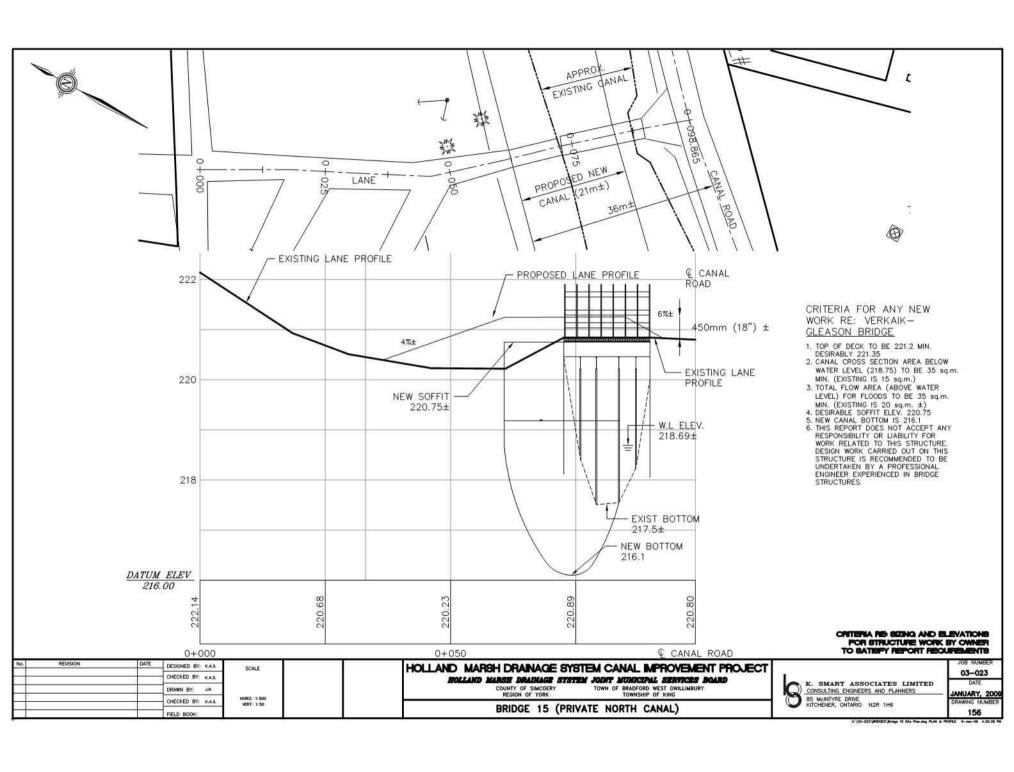



No.	REVISION	DATE	DESIGNED BY: A.G.	SCALE
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BRIDGE 15 (PRIVATE NORTH CANAL)

	K. SMART ASSOCIATES LIMIT CONSULTING ENGINEERS AND PLANNERS
0	85 McINTYRE DRIVE KITCHENER, ONTARIO N2R 1H6

JOB NUMBER 03-023 ANUARY, 2009